
FINAL DESIGN DRAWINGS FOR THE

SWEETWATER DAM 36-INCH RAW WATER PIPELINE REPLACEMENT

SWEETWATER AUTHORITY PROJECT NO. B.P. 20104024 SAN DIEGO COUNTY, CALIFORNIA



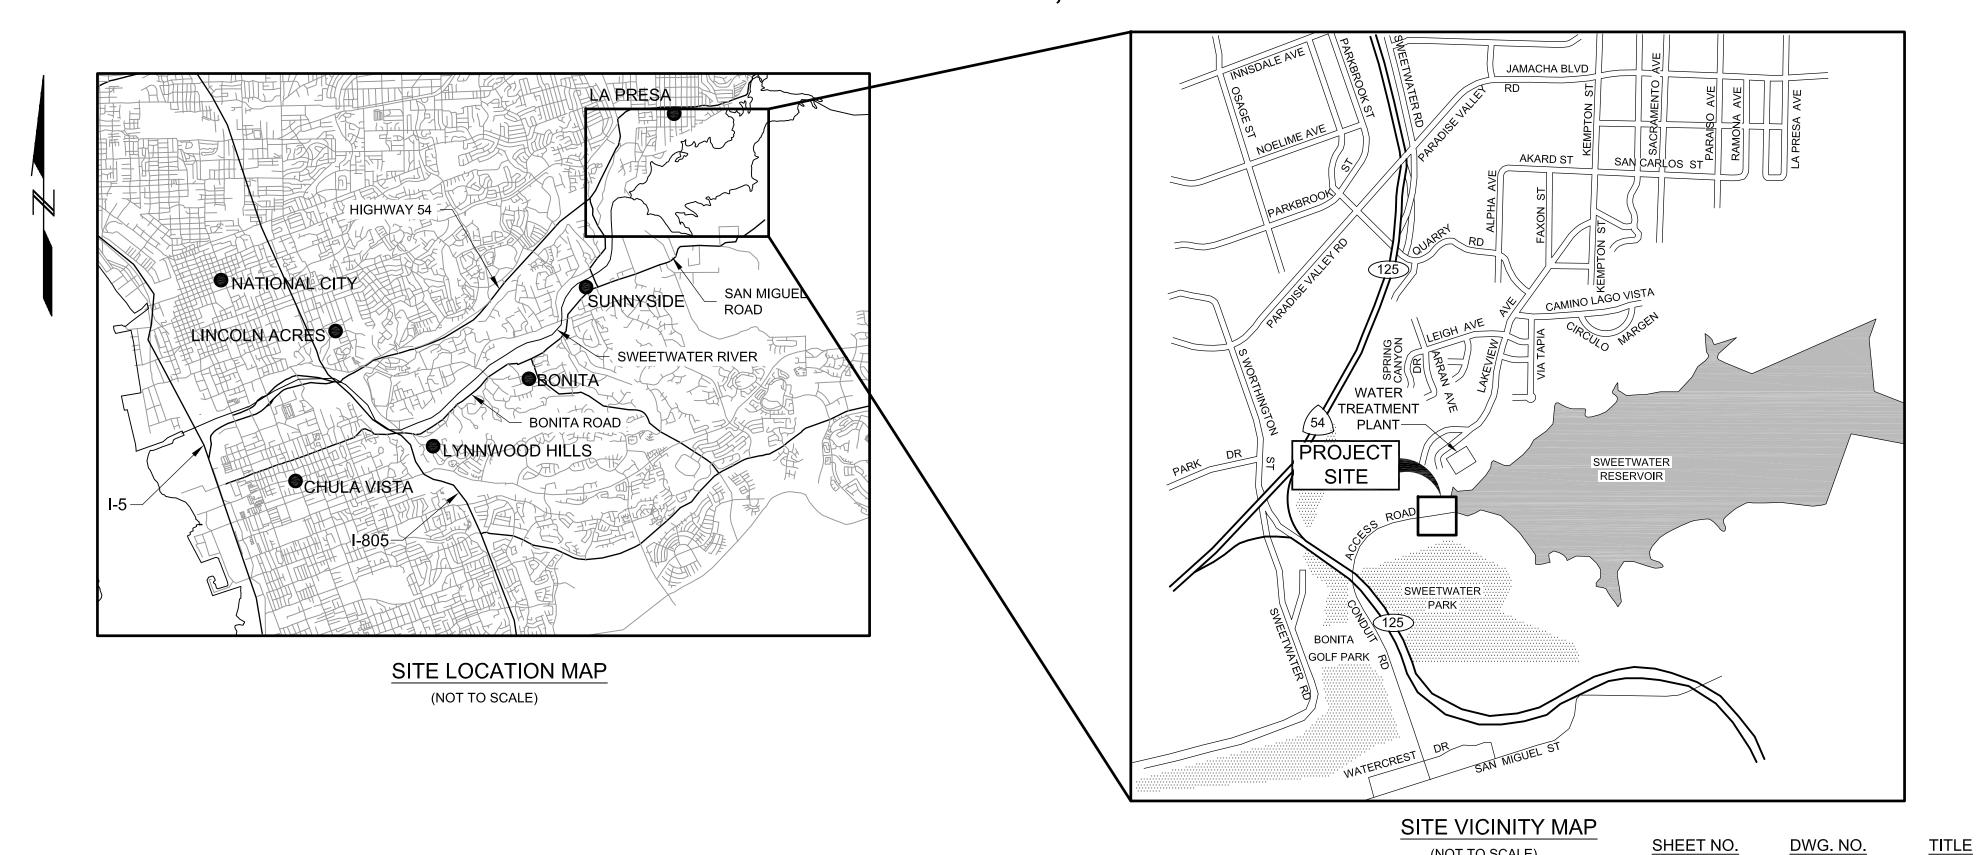

PREPARED BY CARLSBAD • CALIFORNIA

(NOT TO SCALE)

G-01 G-02 G-03 G-04 C-01 C-02 C-03 C-04 C-05 C-06 C-07 C-08 12 13 C-09 C-10 C-11 C-12 CP-01 CORROSION MONITORING DETAILS - 1 CP-02 CORROSION MONITORING DETAILS - 2

TITLE, DRAWING INDEX, AND PROJECT LOCATION MAPS ABBREVIATIONS, SYMBOLS, AND GENERAL NOTES EXISTING CONDITIONS, STAGING AREAS, AND SURVEY CONTROL PLAN - 1 EXISTING CONDITIONS, STAGING AREAS, AND SURVEY CONTROL PLAN - 2 PIPELINE DEMOLITION PLAN PLAN AND PROFILE, STA 10+00 TO STA 15+00 PLAN AND PROFILE, STA 15+00 TO STA 16+49.71 ACCESS RAMP AND CONCRETE DITCH 36"Ø PIPELINE CONNECTION AT STA 10+00 EXISTING STILLING POOL DAM CROSSING 30"Ø PIPE LINING SECTION EXISTING BLOWOFF/VAULT ABANDONMENT AND NEW BLOWOFF INSTALLATION PIPE ENCASEMENT AND LINING DETAILS TYPICAL DETAILS- 1 TYPICAL DETAILS- 2 TYPICAL DETAILS- 3

PLANS FOR THE INSTALLATION OF:

THIS DOCUMENT, AND THE IDEAS AND DESIGNS INCORPORATED HEREIN, AS AN INSTRUMENT OF PROFESSIONAL SERVICE, IS THE PROPERTY OF GEI CONSULTANTS, INC. AND IS NOT TO BE USED, IN WHOLE OR IN PART, FOR ANY OTHER PROJECT WITHOUT THE WRITTEN AUTHORIZATION OF GEI CONSULTANTS, INC.



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			1/4 SECTION		W.O. # N/A				
REV.	DATE	DESCRIPTION	BY	APPVD.	DESIGN BY: M. HARGROVE	SCALE: AS NOTED	GEI CONSULTANTS INC.	5-18-2011	B.P. # 20104024
Α					DRAWN BY: K. CHUNG	DATE: MAY 18, 2011	ENGINEER PE	DATE	SHEET
В					CHECKED BY: M. ROZMAN	DESIGN #: 20104024	SWEETWATER AUTHORITY	5-18-2011	1 OF 18
С					AS CONSTRUCTED:	PAVEMENT#: N/A	APPROVED	DATE	1 01 10

G-01


SWEETWATER AUTHORITY

SWEETWATER DAM

36-INCH RAW WATER PIPELINE REPLACEMENT

TITLE, DRAWING INDEX, AND

PROJECT LOCATION MAPS

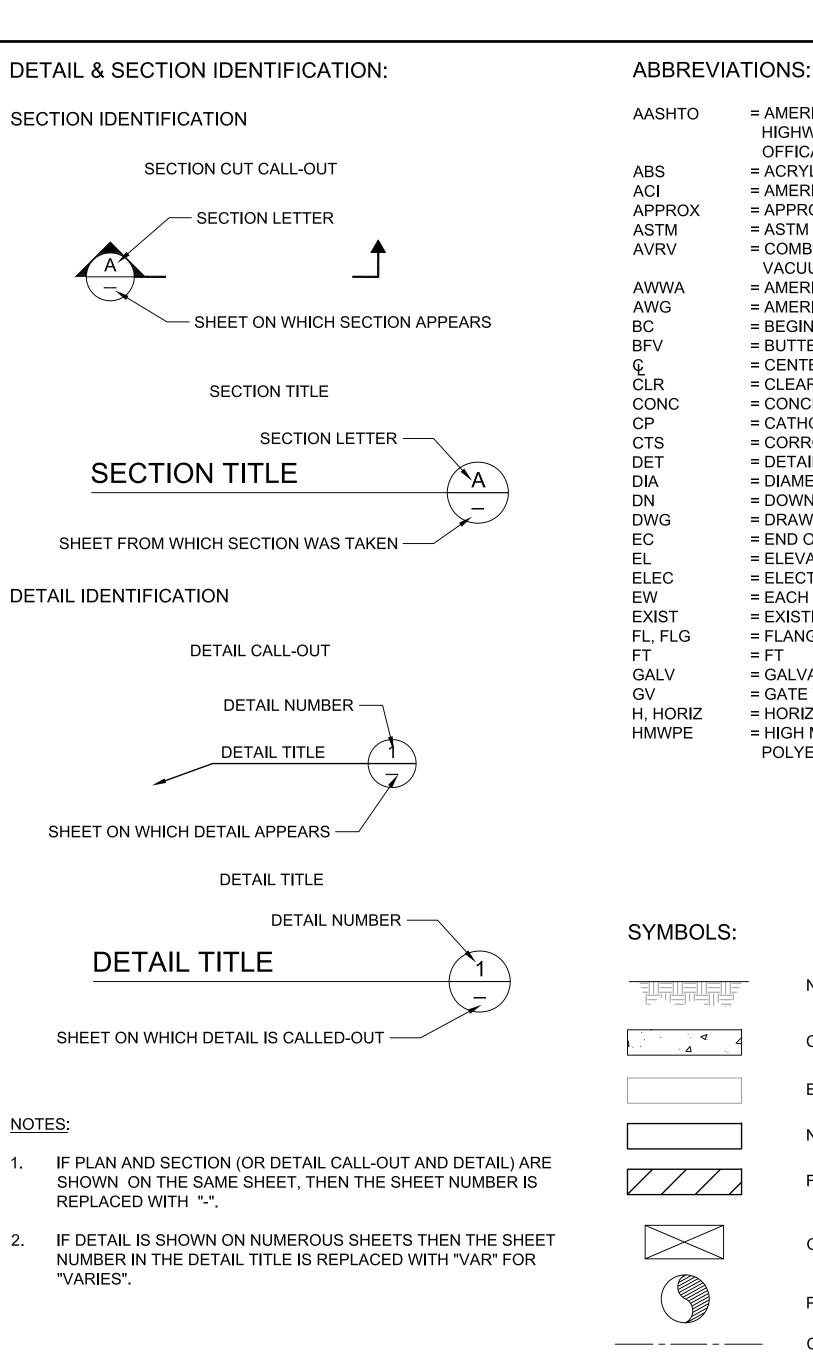

APPROX = APPROXIMATE NTS = NOT TO SCALE = MAXIMUM ASTM = ASTM INTERNATIONAL MAX **AVRV** = COMBINATION AIR RELEASE AND MIN = MINIMUM = MECHANICAL JOINT VACUUM RELIEF VALVE MJ NGVD = NATIONAL GEODETIC VERTICAL DATUM **AWWA** = AMERICAN WATER WORKS ASSOCIATION **AWG** NO = NUMBER = AMERICAN WIRE GAUGE ВС = BEGINNING OF CURVE NOM = NOMINAL NPT = NATIONAL PIPE THREAD BFV = BUTTERFLY VALVE = CENTERLINE OD = OUTSIDE DIAMETER CLR = CLEAR = PROPERTY LINE CONC = CONCRETE = POINT OF INTERSECTION PSI CP = POUNDS PER SQUARE INCH = CATHODIC PROTECTION **CTS** = CORROSION TEST STATION PVC = POLYVINYL CHLORIDE DET = DETAIL RECT = RECTANGULAR DIA = DIAMETER REQ = REQUIRED, REQUIREMENT DN = DOWN = SLOPE DWG = DRAWING SCH = SCHEDULE EC SDCWA = SAN DIEGO COUNTY WATER AUTHORITY = END OF CURVE = SPECIFICATION EL SPEC = ELEVATION **ELEC** = ELECTRICAL SQ = SQUARE STA = STATION ΕW = EACH WAY **EXIST** = EXISTING STD = STANDARD FL, FLG = FLANGE SS = STAINLESS STEEL = FT TYP = TYPICAL GALV V. VERT = GALVANIZED = VERTICAL = VERTICAL POINT OF INTERSECTION GV = GATE VALVE VPI H, HORIZ = HORIZONTAL = WITH = HIGH MOLECULAR WEIGHT WT = WEIGHT = AT **POLYETHYLENE** = DIAMETER = PERCENT = NUMBER SYMBOLS:

= AMERICAN ASSOCIATION OF STATE

HIGHWAY AND TRANSPORTATION

= AMERICAN CONCRETE INSTITUTE

= ACRYLONITRILE BUTADIENE STYRENE

OFFICALS

NEW BLOWOFF NATIVE EARTH/ROCK **EXISTING WATER PIPE** CONCRETE X- - -X- - -**EXISTING FENCE** ——200—— EXISTING/NEW MAJOR CONTOUR **EXISTING STRUCTURE OR EXISTING FACILITY EXISTING/NEW MINOR CONTOUR** $\times 152.50$ **EXISTING SPOT ELEVATION** NEW STRUCTURE OR NEW FACILITY TOP FILL/CUT SLOPE TO BE CONSTRUCTED FACILITIES TO BE DEMOLISHED **EXISTING WATER COURSE** EXISTING TRAIL OR DIRT ROAD **OPENING** EXISTING LIMITS OF VEGETATION (TREES, SHRUBS ETC.) PIPE IN SECTION CONTROL POINT/BENCHMARK CENTERLINE **EXISTING POWER POLE NEW PIPELINE** _____

= INTERNAL DIAMETER

= NORTH AMERICAN DATUM

= NATIONAL STANDARD THREAD

= INVERT

= POUNDS

ID

INV

LBS

NAD

NST

GENERAL NOTES:

- 1. THE WATER FACILITIES SHOWN ON THESE PLANS SHALL BE CONSTRUCTED IN ACCORDANCE WITH PROJECT'S CONTRACT DOCUMENTS.
- 2. ANY WATER FACILITIES BACK FILLED WITHOUT INSPECTION BY SWEETWATER AUTHORITY ARE SUBJECT TO EXCAVATION AND REMOVAL. THE EXPENSE FOR EXCAVATION, REMOVAL AND REPLACEMENT WILL BE BORNE BY THE CONTRACTOR.
- 3. THE CONTRACTOR WILL SUPPLY ALL MATERIAL FOR WATER IMPROVEMENTS INCLUDING SHOP DRAWINGS WHERE APPROPRIATE.
- 4. THE CONTRACTOR IS CAUTIONED TO DETERMINE LOCATION OF ALL UTILITIES WHICH MAY OR MAY NOT BE RECORDED ON THESE PLANS.
- 5. NO WORK SHALL COMMENCE ON THE SITE PRIOR TO A PRE-CONSTRUCTION MEETING.
- 6. ALL OPERATIONS CONDUCTED ON THE COUNTY OF SAN DIEGO RIGHT-OF-WAY, INCLUDING THE WARMING UP, REPAIR, ARRIVAL, DEPARTURE, OR RUNNING OF TRUCK EARTH MOVING EQUIPMENT, CONSTRUCTION EQUIPMENT AND ANY OTHER ASSOCIATED EQUIPMENT SHALL BE LIMITED TO THE PERIOD BETWEEN 7:00 A.M. AND 5:00 P.M. EACH DAY, MONDAY -FRIDAY. PRIOR APPROVAL OF THE COUNTY ENGINEER WILL BE REQUIRED FOR WORK BEFORE 7:00AM & AFTER 5:00PM
- 7. THE CONTRACTOR SHALL MAKE EXPLORATORY EXCAVATIONS TO VERIFY EXISTING UTILITY LOCATIONS SUFFICIENTLY AHEAD OF CONSTRUCTION TO ALLOW TIME FOR REVISION REQUIRED BY **EXISTING CONDITIONS.**
- 8. IT SHALL BE THE RESPONSIBILITY OF THE CONTRACTOR TO LOCATE ALL SUBSTRUCTURES WHETHER SHOWN OR NOT & PROTECT THEM FROM DAMAGE. THE EXPENSE OF REPAIR AND OR REPLACEMENT OF SAID SUBSTRUCTURES SHALL BE BORNE BY THE CONTRACTOR.
- 9. NEITHER THE OWNER, NOR THE ENGINEER OF WORK WILL ENFORCE SAFETY MEASURES OR REGULATIONS. THE CONTRACTOR SHALL DESIGN, CONSTRUCT, & MAINTAIN ALL SAFETY DEVICES, INCLUDING SHORING, AND SHALL BE SOLELY RESPONSIBLE FOR CONFORMING TO LOCAL, STATE & FEDERAL SAFETY & HEALTH STANDARDS, LAWS & REGULATIONS.
- 10. THE CONTRACTOR AGREES THAT THEY SHALL ASSUME SOLE AND COMPLETE RESPONSIBILITY FOR JOB SITE CONDITIONS DURING THE COURSE OF CONSTRUCTION OF THIS PROJECT, INCLUDING SAFETY OF ALL PERSONS AND PROPERTY: THAT THIS REQUIREMENT SHALL APPLY CONTINUOUSLY AND NOT BE LIMITED TO NORMAL WORKING HOURS: AND THAT THE CONTRACTOR SHALL DEFEND, INDEMNIFY AND HOLD THE OWNER AND THE ENGINEER HARMLESS FROM ANY AND ALL LIABILITY, REAL OR ALLEGED, IN CONNECTION WITH THE PERFORMANCE OF WORK ON THIS PROJECT.
- 11. ADEQUATE COMPACTION TESTING SHALL BE PERFORMED AND RESULTS SUBMITTED TO THE SWEETWATER AUTHORITY ENGINEERING INSPECTOR.
- 12. THE DISCHARGE OF NON STORMWATER POLLUTANTS TO THE STORMWATER CONVEYANCE SYSTEM OR SWEETWATER RIVER IS PROHIBITED. ALL STORMDRAIN INLETS AND RIVER SHALL BE PROTECTED USING THE STANDARDIZED BEST MANAGEMENT PRACTICES AND THE USE OF GRAVEL BAGS AND/OR OTHER PROTECTIVE BARRICADES. THE CONTRACTOR SHALL BE REQUIRED TO CONSTRUCT, MONITOR, AND MAINTAIN ALL STORM WATER STANDARDIZED BEST MANAGEMENT PRACTICES AT THE SITE.
- 13. EXISTING STRUCTURES IN WHICH PORTIONS ARE TO BE REMOVED ONLY, SHALL BE SAWCUT TO A NEAT LINE FINISH. ALL SAWCUT SLURRY, DEVELOPED AS A RESULT OF SAWCUTTING, SHALL BE REMOVED BY USE OF VACUUM.

UTILITY NOTES:

CONTRACTOR SHALL VERIFY THE EXISTENCE AND LOCATION OF ALL UTILITIES BEFORE COMMENCING WORK. NOTICE OF PROPOSED WORK SHALL BE GIVEN TO THE FOLLOWING AGENCIES:

UNDERGROUND SERVICE ALERT 811 SWEETWATER AUTHORITY

619-420-1413

G-02

SWEETWATER AUTHORITY

SWEETWATER DAM 36-INCH RAW WATER PIPELINE REPLACEMENT

ABBREVIATIONS, SYMBOLS,

AND GENERAL NOTES

PLANS FOR THE INSTALLATION OF:



NEW COMBINATION AIR AND VACUUM VALVE


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FOR BIDDING PURPOSES ONLY NOT FOR CONSTRUCTION

LIMITS OF WORK (WITH AND WITHOUT HATCHING)

							1/4 SECTION		W.O. # N/A
REV.	DATE	DESCRIPTION	BY	APPVD.	DESIGN BY: M. HARGROVE	SCALE: AS NOTED	GEI CONSULTANTS INC.	5-18-2011	B.P. # 20104024
Α					DRAWN BY: K. CHUNG	DATE: MAY 18, 2011	ENGINEER PE	DATE	SHEET
В					CHECKED BY: M. ROZMAN	DESIGN #: 20104024	SWEETWATER AUTHORITY	5-18-2011	2 OF 18
С					AS CONSTRUCTED:	PAVEMENT#: N/A	APPROVED	DATE	2 01 10



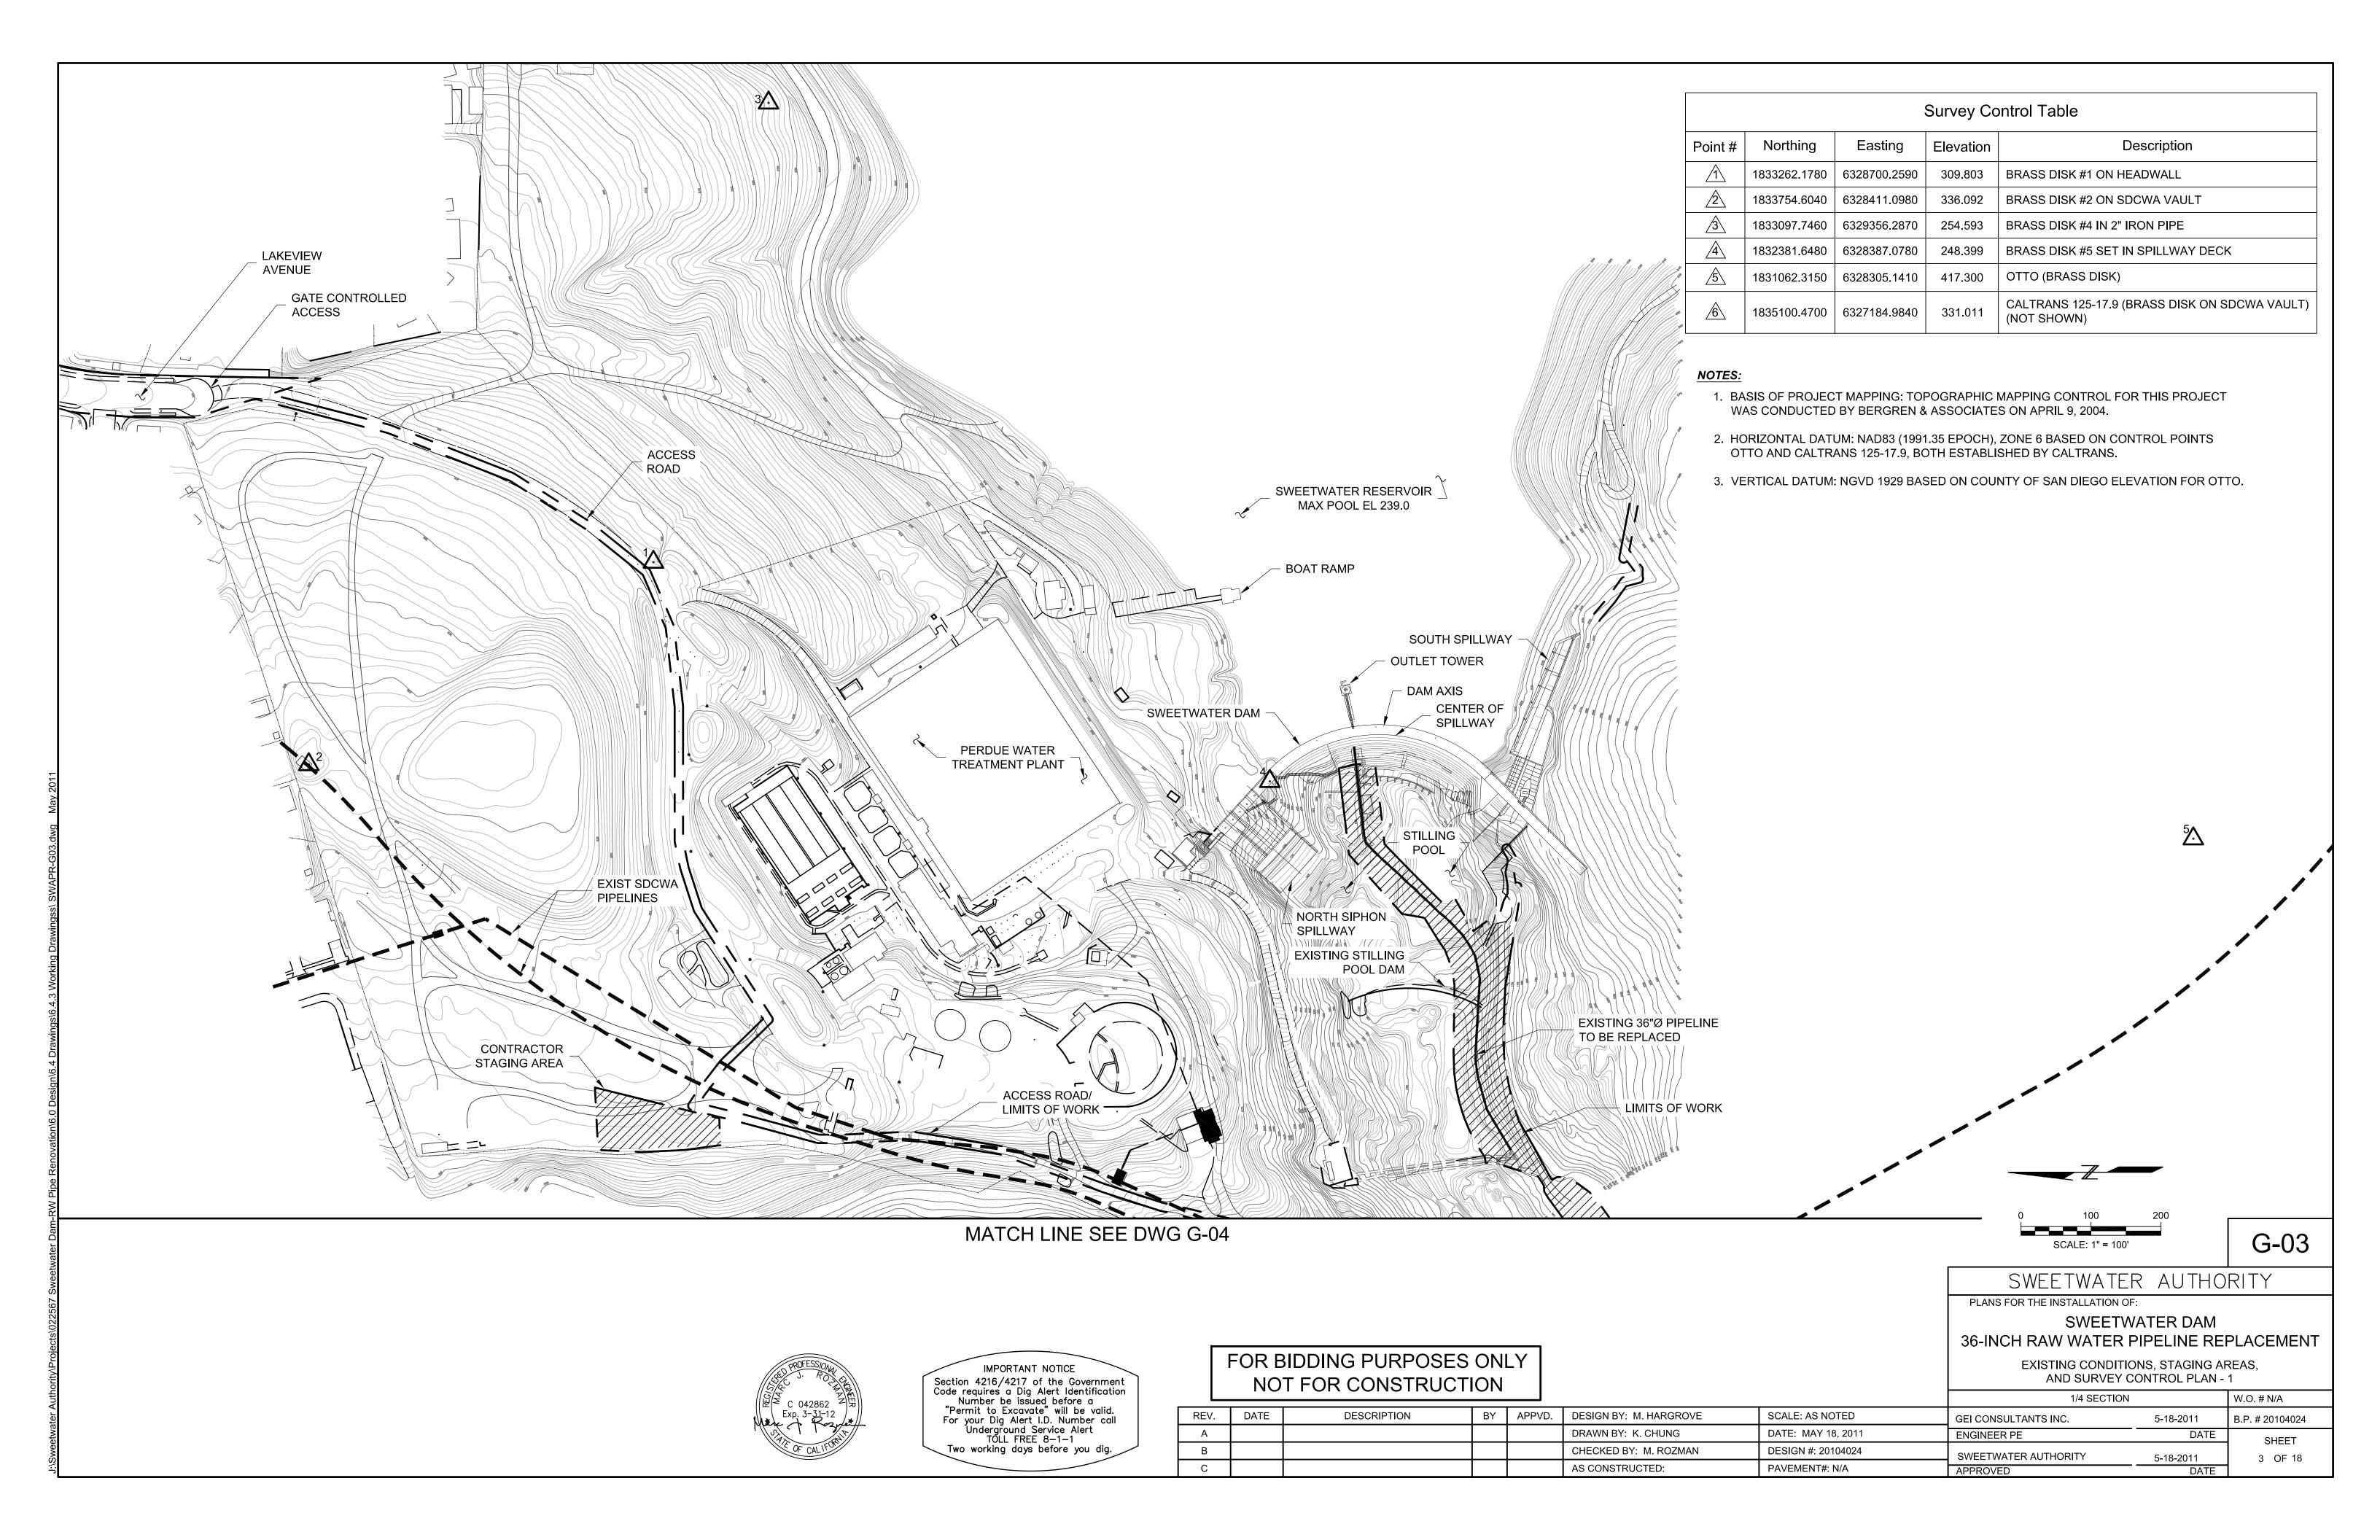

1. SWEETWATER AUTHORITY WILL COORDINATE AND FIELD LOCATE EXISTING SAN DIEGO COUNTY WATER AUTHORITY (SDCWA) PIPELINES ON ALL ROAD CROSSINGS THAT CONSTRUCTION VEHICLES AND EQUIPMENT WILL BE USING . SWEETWATER AUTHORITY WILL PROVIDE STEEL PLATING OVER PIPELINE CROSSING TO PROTECT PIPELINES. CONTRACTOR SHALL EXERCISE CAUTION WHEN CROSSING PIPELINES WITH VEHICLES AND EQUIPMENT. CONTRACTOR WILL BE REQUIRED TO ATTEND AT LEAST ONE CONSTRUCTION/COORDINATION MEETING WITH SWEETWATER AUTHORITY AND SDCWA RELATED TO THIS ROAD CROSSING ISSUE.



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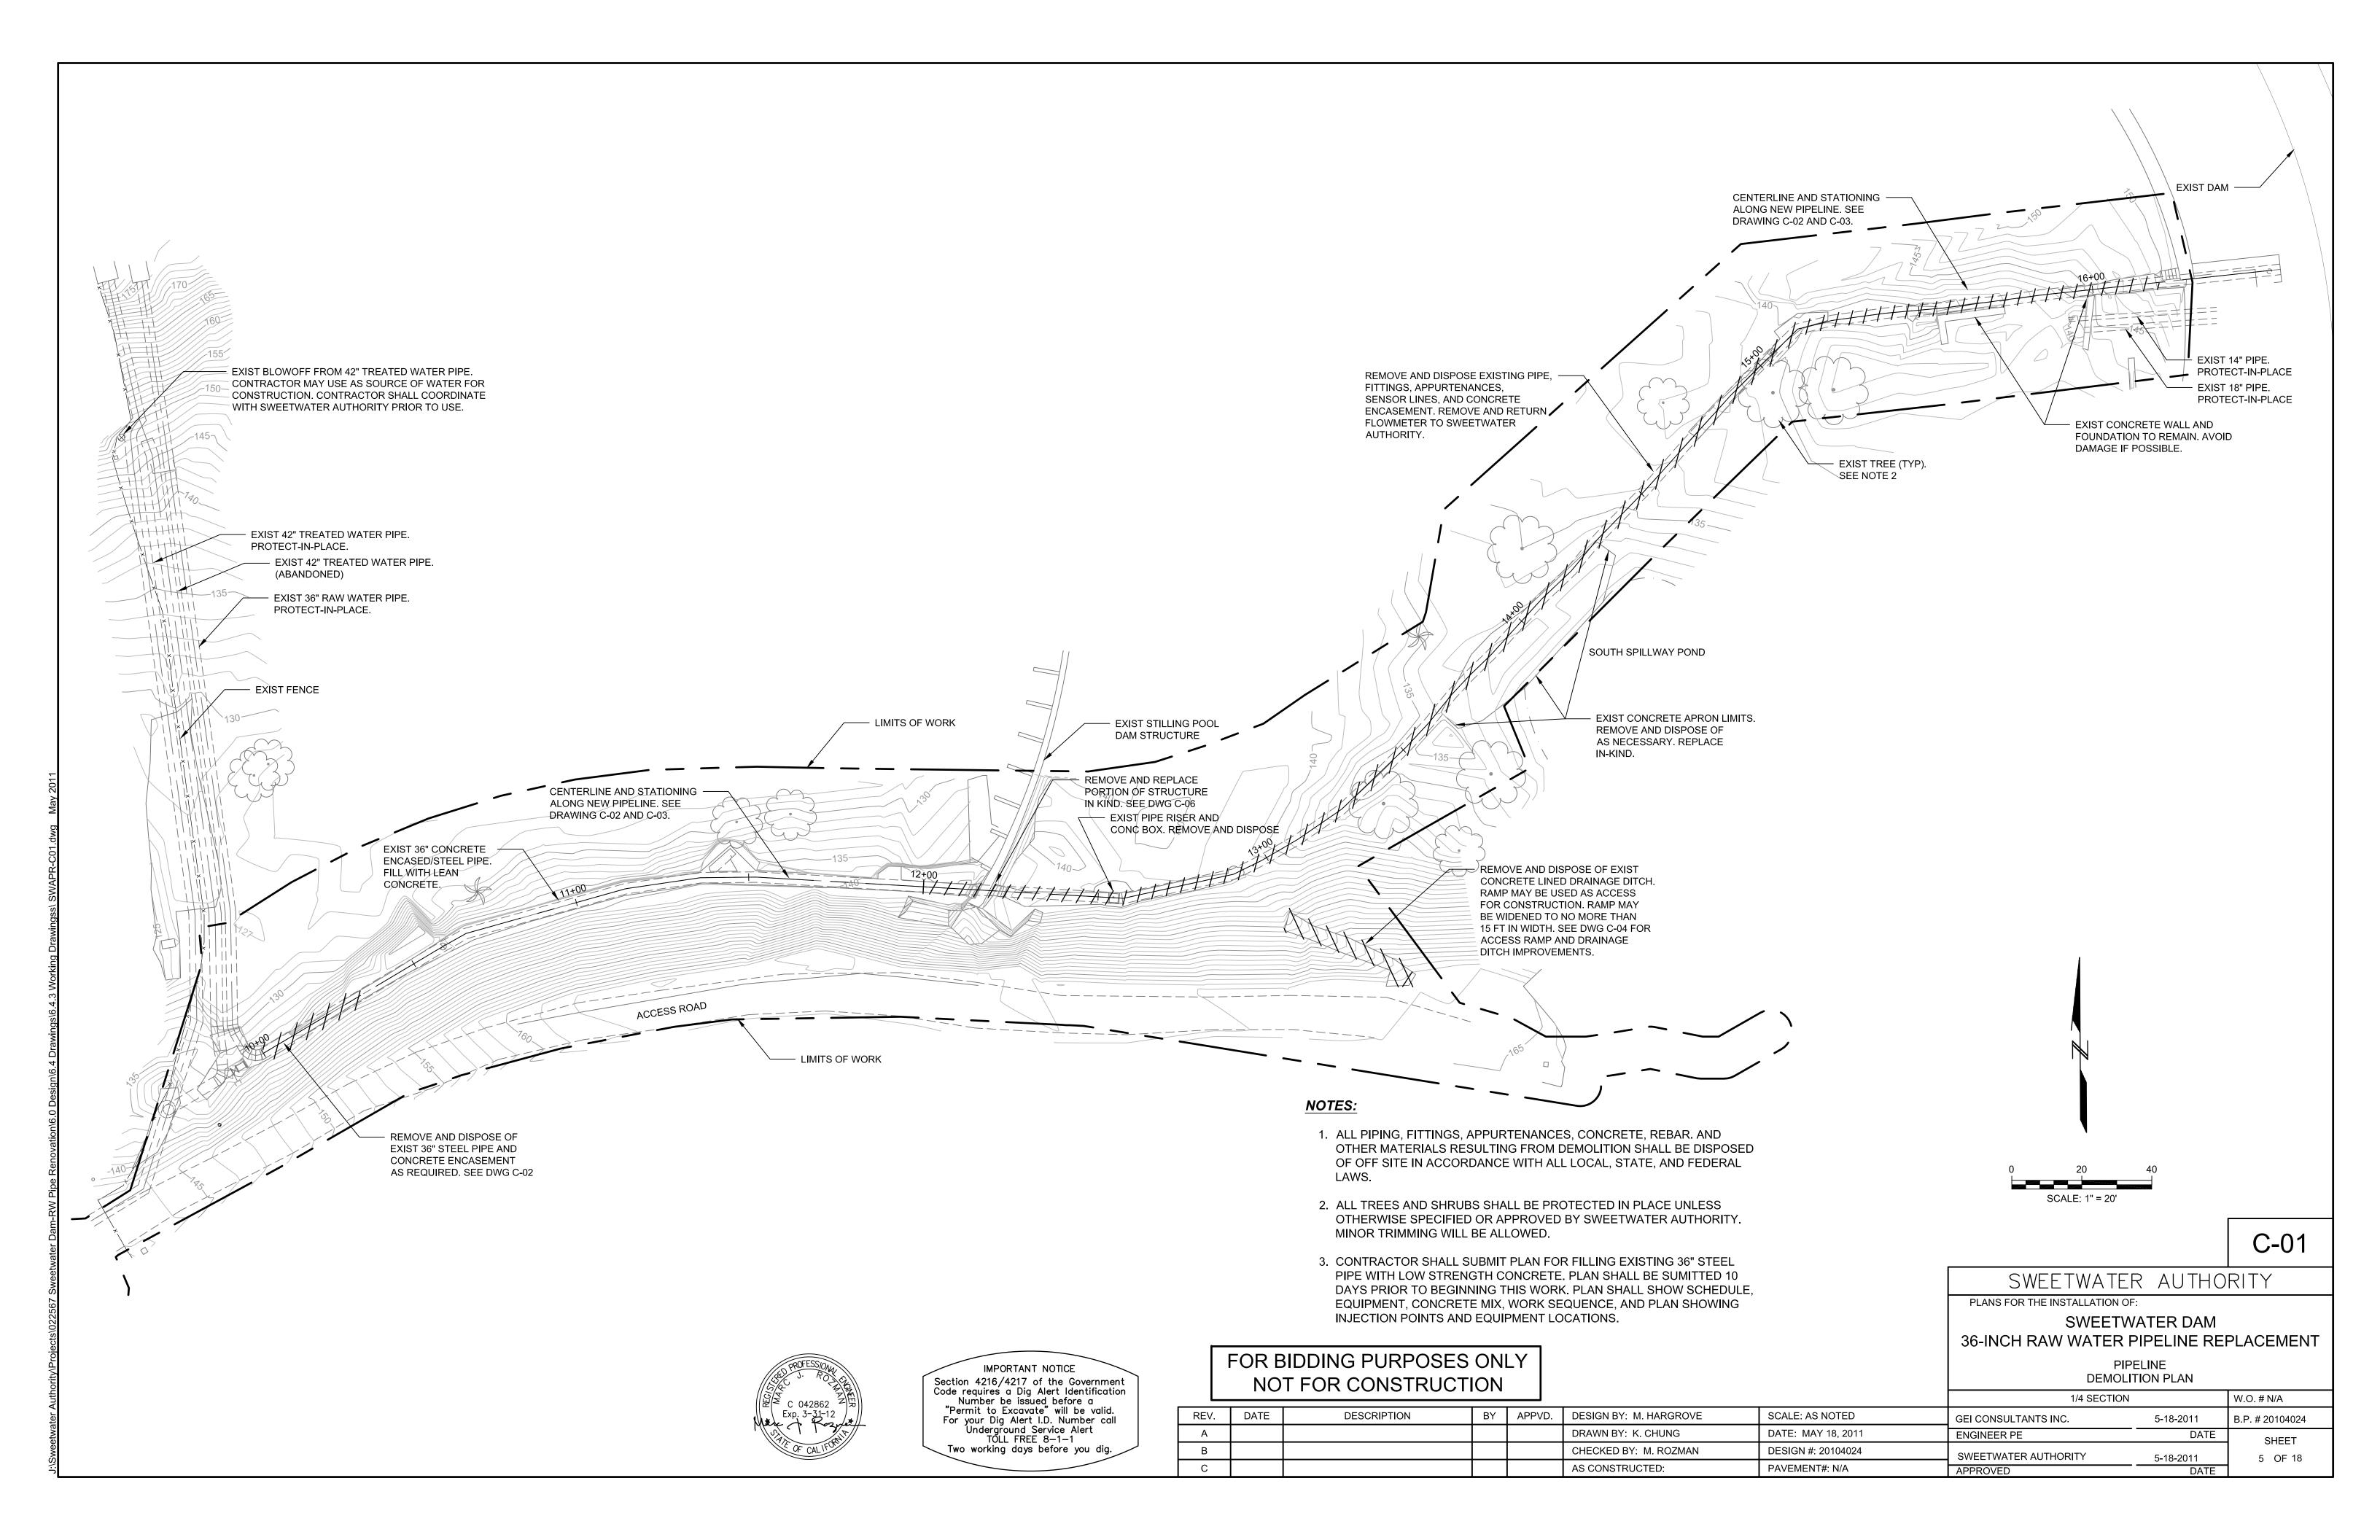
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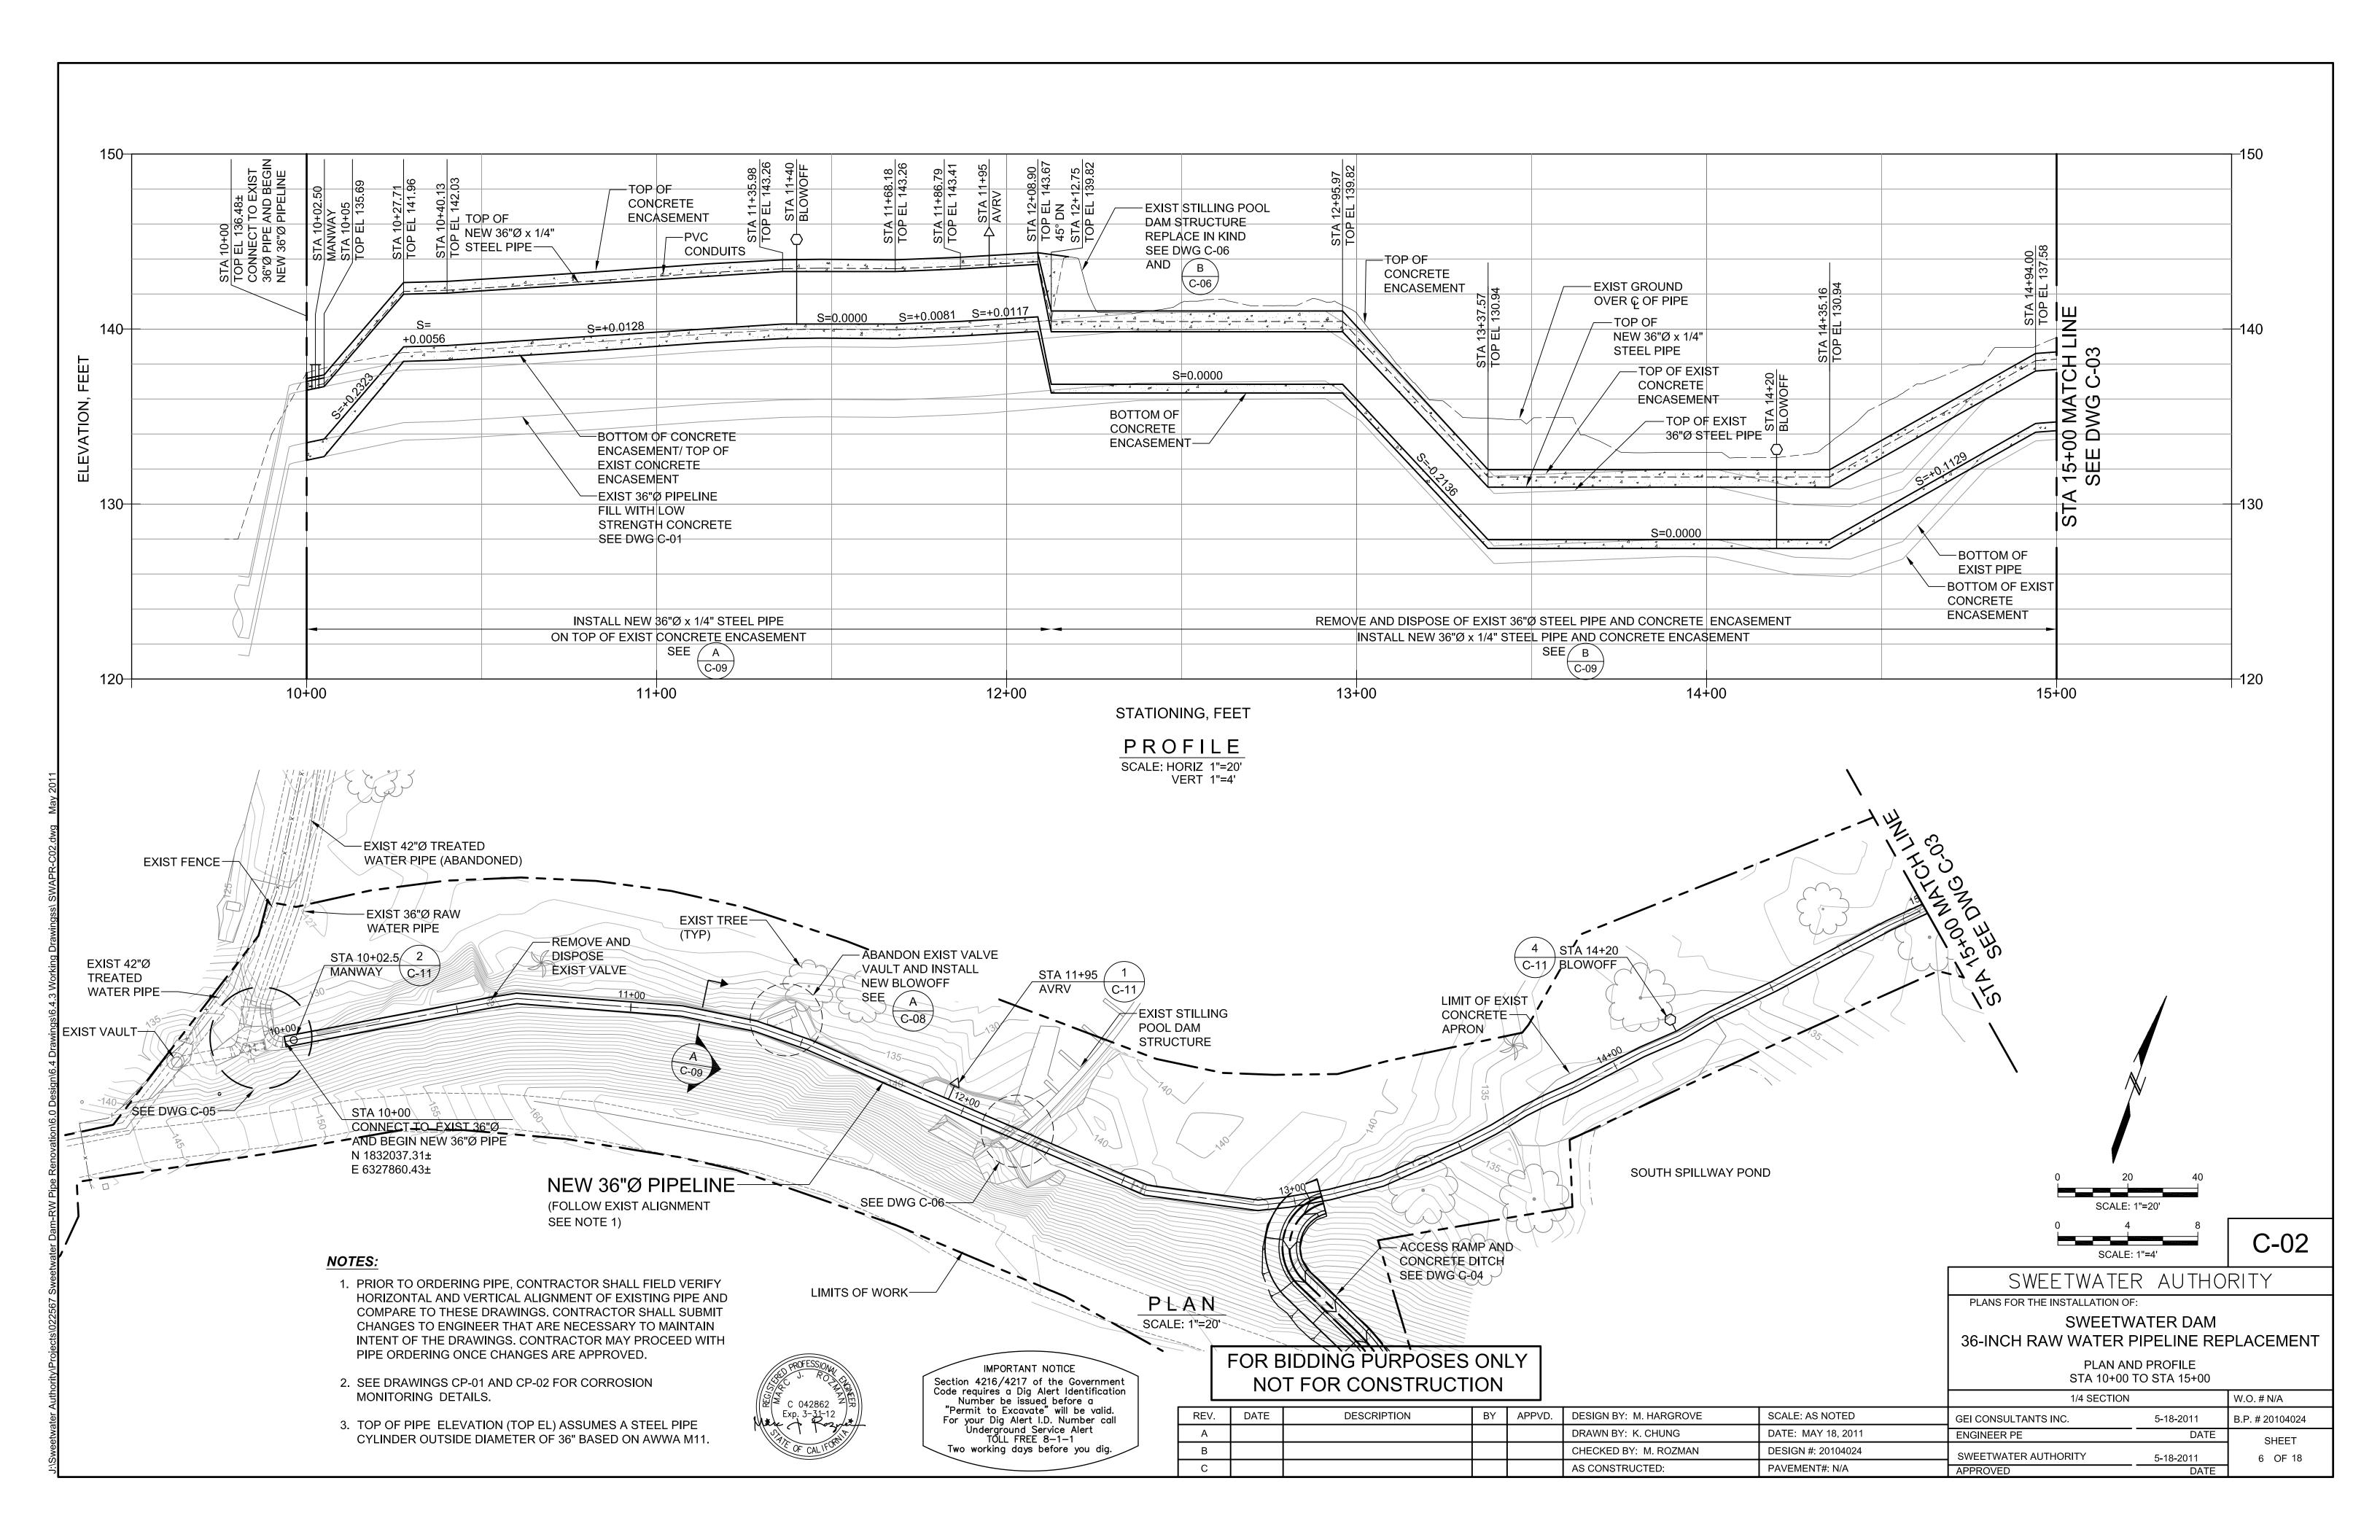
SWEETWATER AUTHORITY


PLANS FOR THE INSTALLATION OF:


SWEETWATER DAM 36-INCH RAW WATER PIPELINE REPLACEMENT

EXISTING CONDITIONS, STAGING AREAS, AND SURVEY CONTROL PLAN - 2





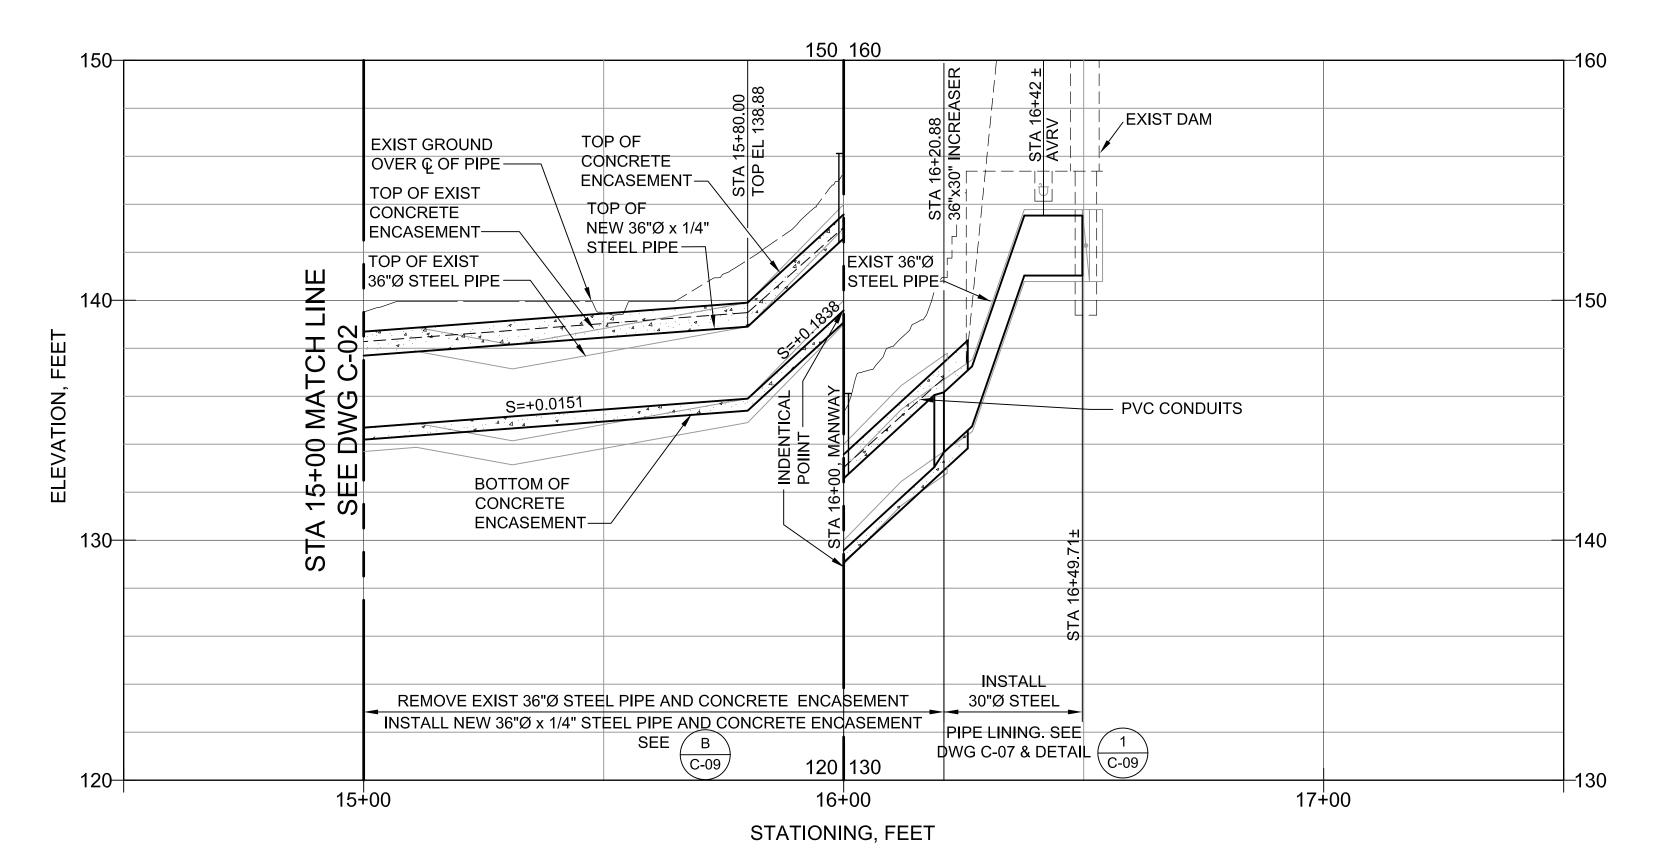

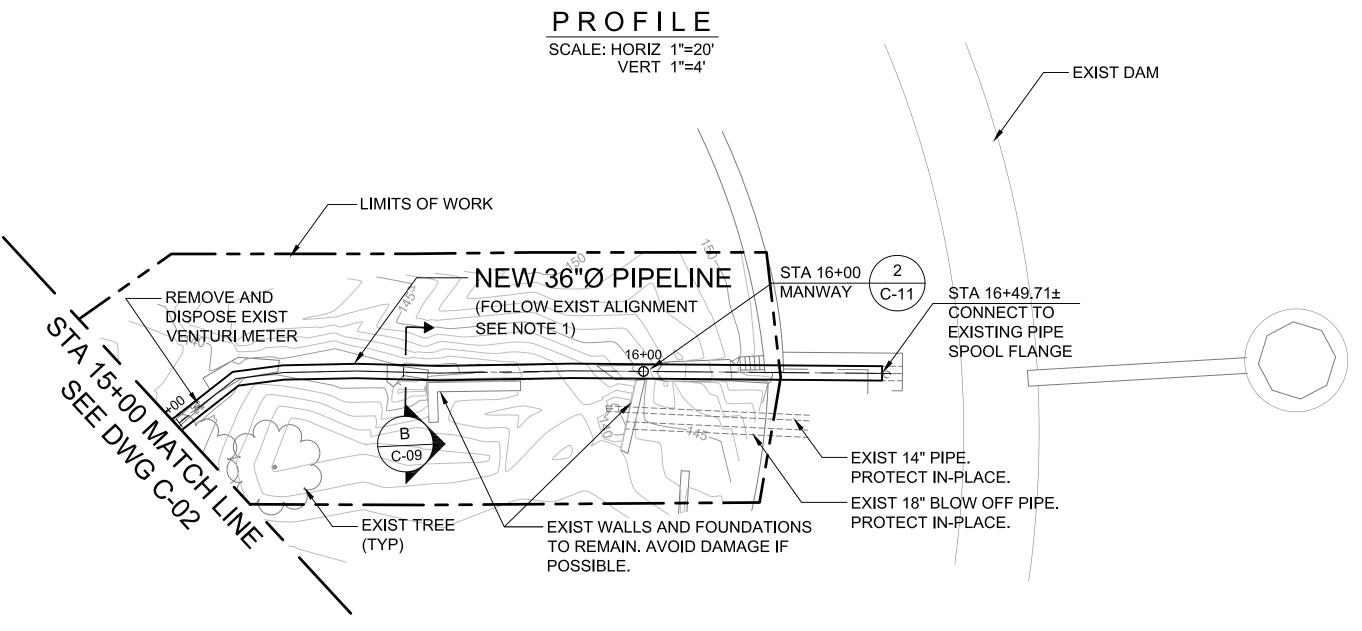

- 1. PRIOR TO ORDERING PIPE, CONTRACTOR SHALL FIELD VERIFY HORIZONTAL AND VERTICAL ALIGNMENT OF EXISTING PIPE AND COMPARE TO THESE DRAWINGS. CONTRACTOR SHALL SUBMIT CHANGES TO ENGINEER THAT ARE NECESSARY TO MAINTAIN INTENT OF THE DRAWINGS. CONTRACTOR MAY PROCEED WITH PIPE ORDERING ONCE CHANGES ARE APPROVED.
- 2. SEE DRAWINGS CP-01 AND CP-02 FOR CORROSION MONITORING DETAILS.
- 3. TOP OF PIPE (TOP) ELEVATION ASSUMES A STEEL PIPE CYLINDER OUTSIDE DIAMETER OF 36" BASED ON AWWA M11.






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В					CHECKED BY: M. ROZMAN	DESIGN #: 20104024	SWEETWATER AUTHORITY	5-18-2011	7 OF 18
С					AS CONSTRUCTED:	PAVEMENT#: N/A	APPROVED	DATE	7 01 10




C-03

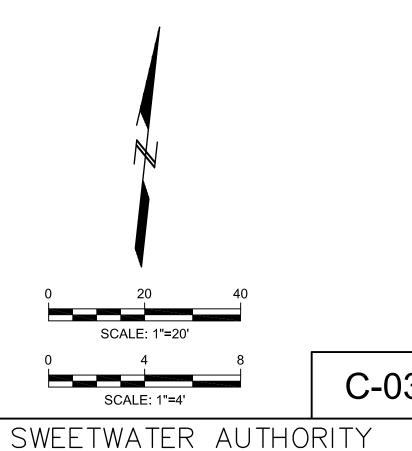
PLANS FOR THE INSTALLATION OF:


SWEETWATER DAM 36-INCH RAW WATER PIPELINE REPLACEMENT

> PLAN AND PROFILE STA 15+00 TO STA 16+49.71

1/4 SECTION		W.O. # N/A
GEI CONSULTANTS INC.	5-18-2011	B.P. # 20104024
ENGINEER PE	DATE	SHFFT
SWEETWATER AUTHORITY	5-18-2011	7 OF 18
APPROVED	DATE	

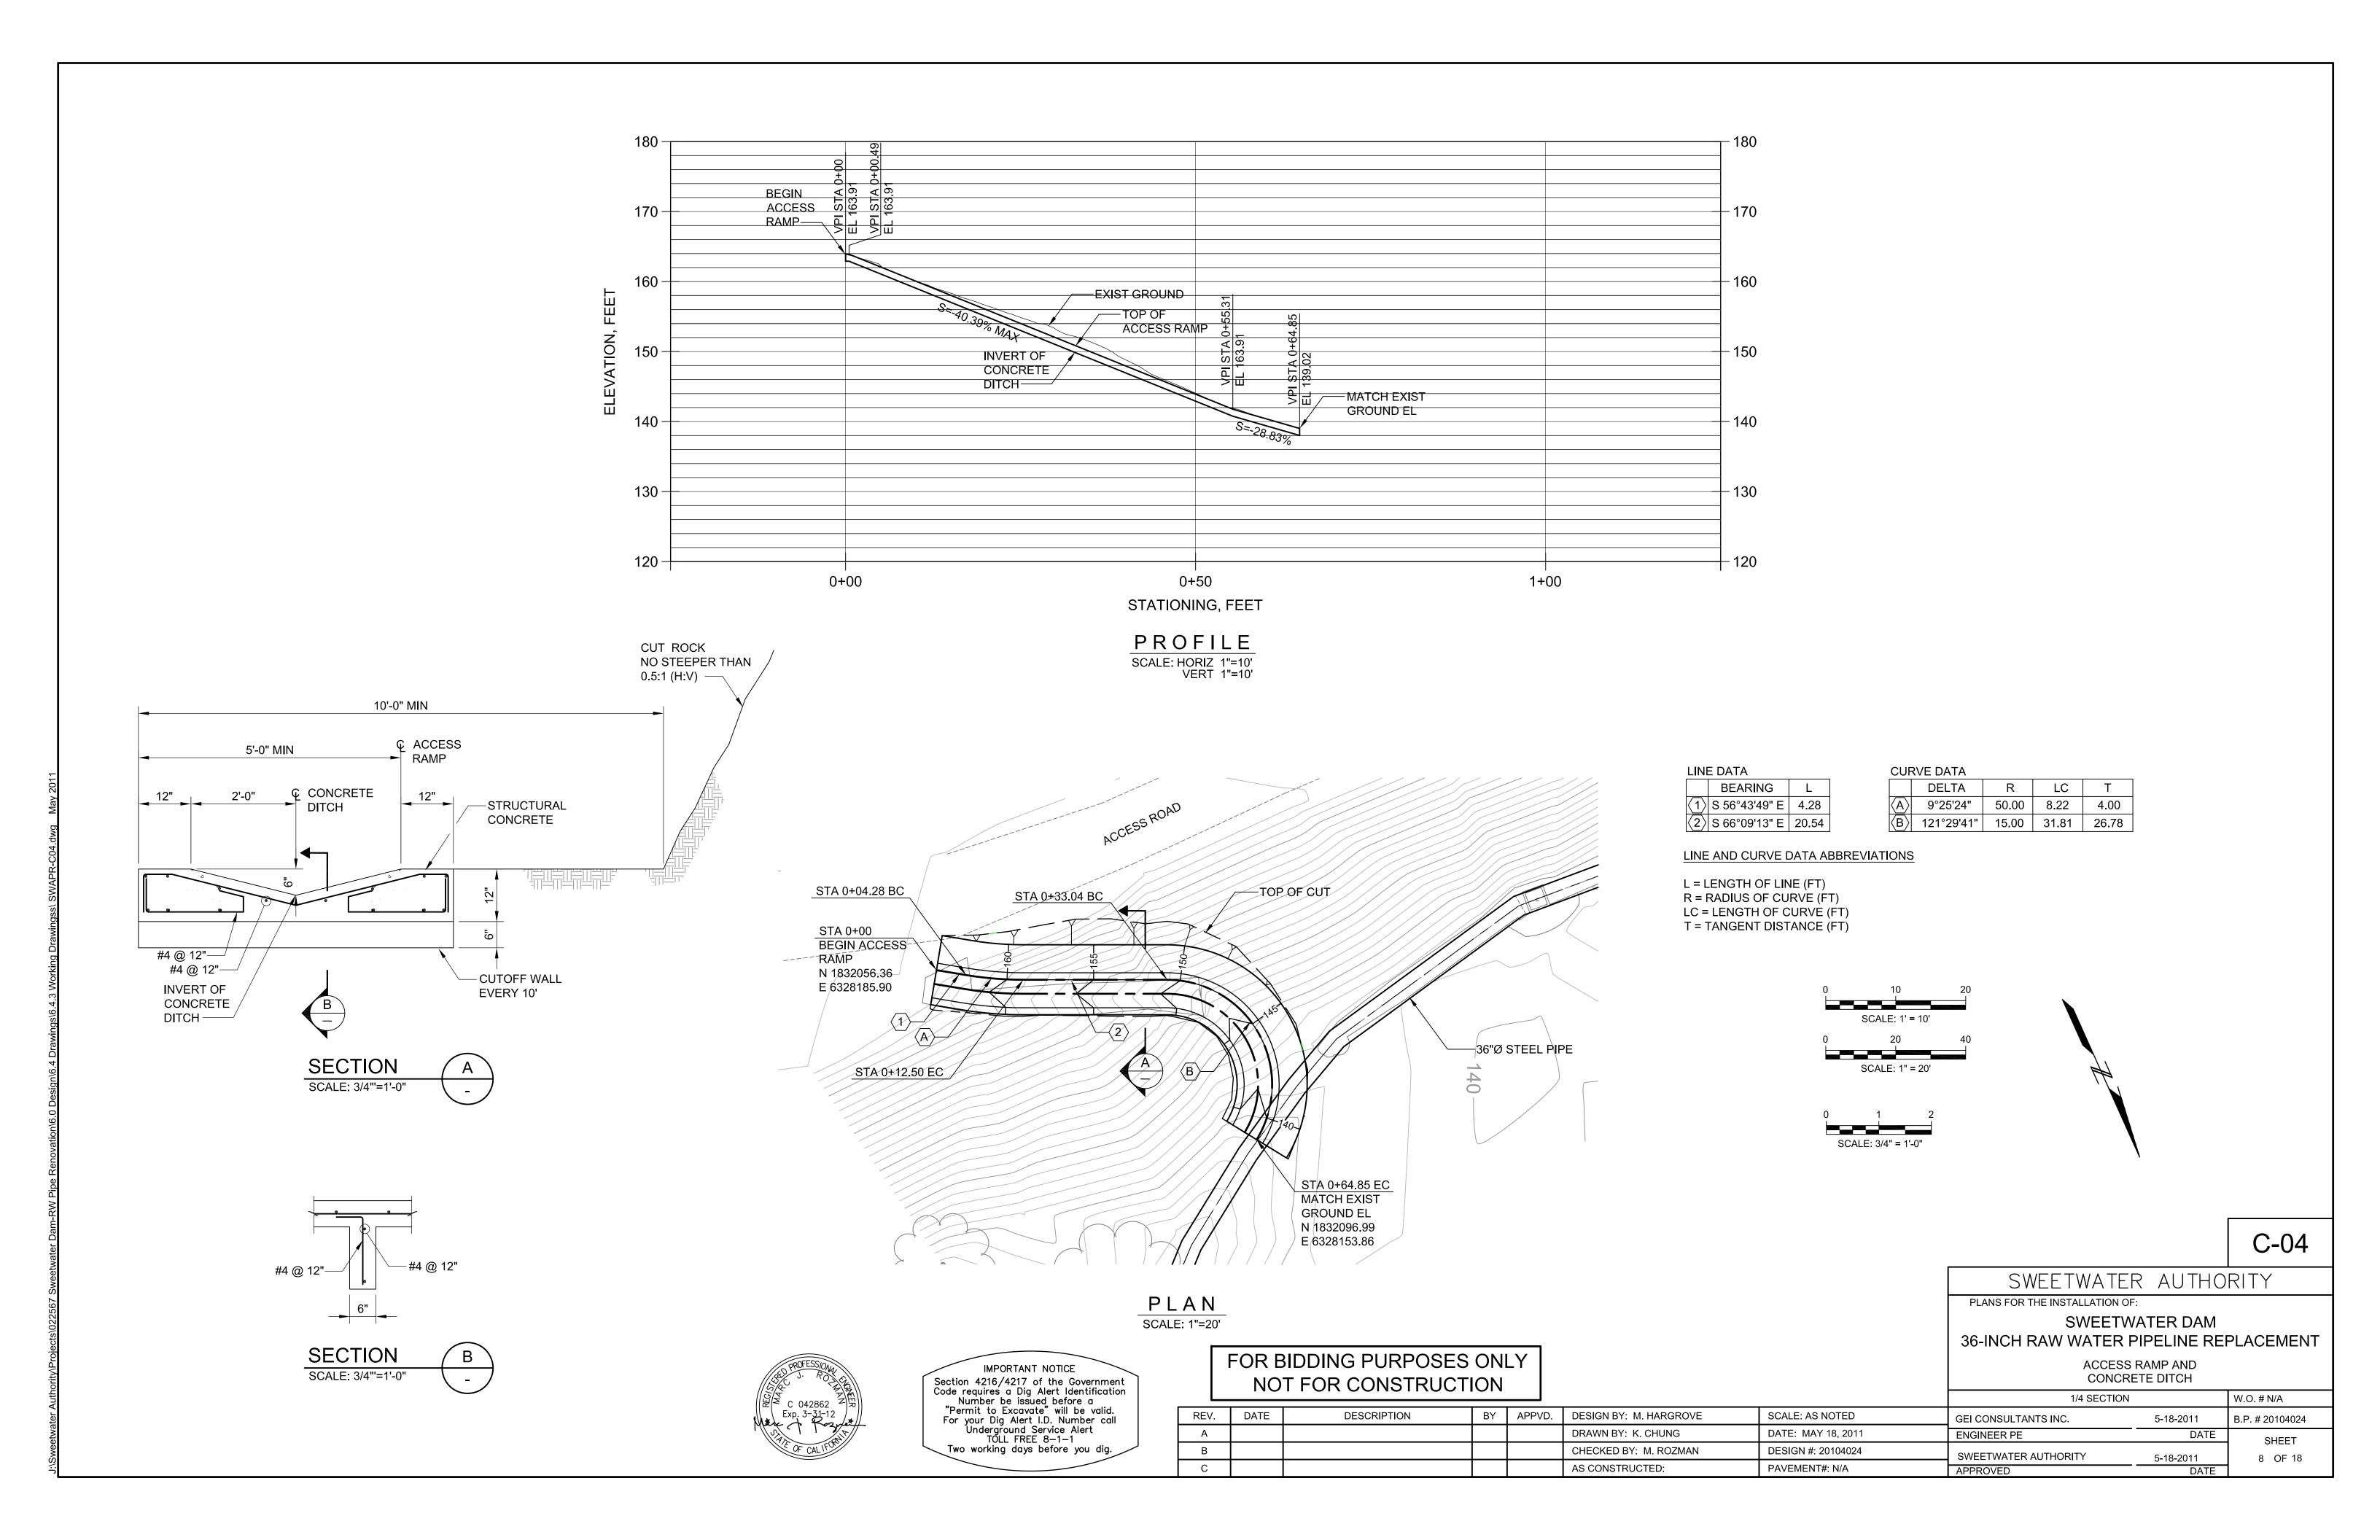

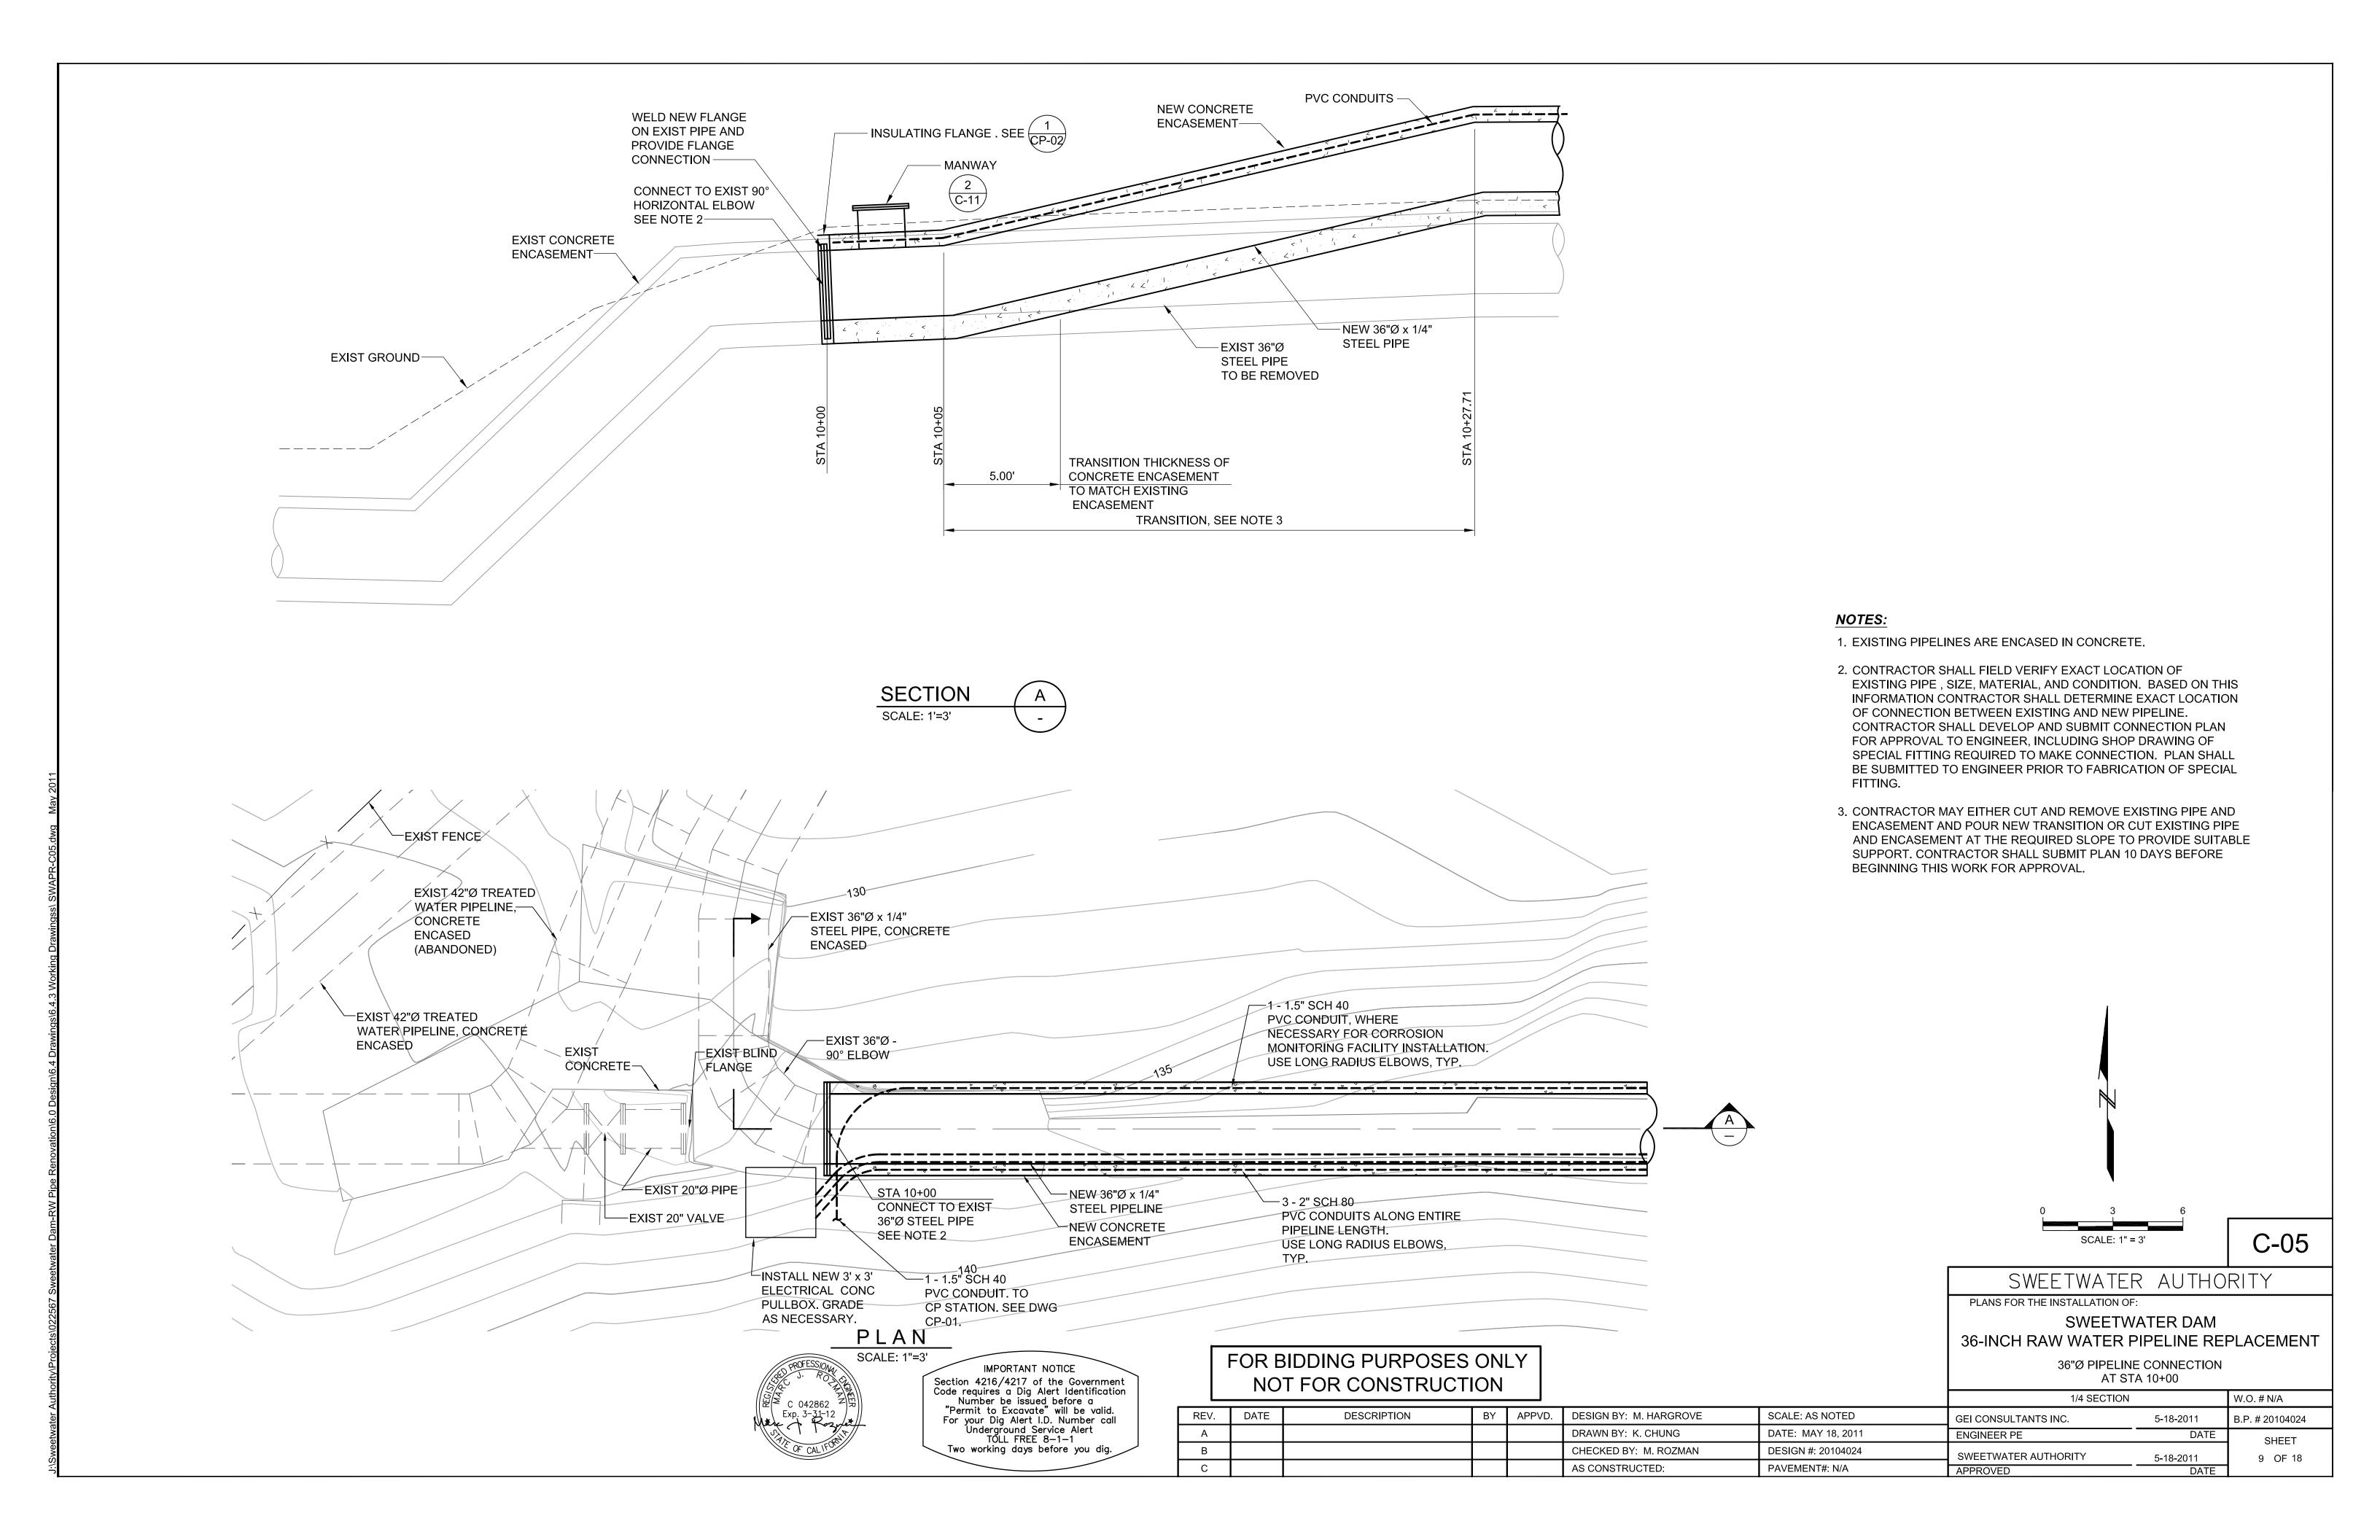

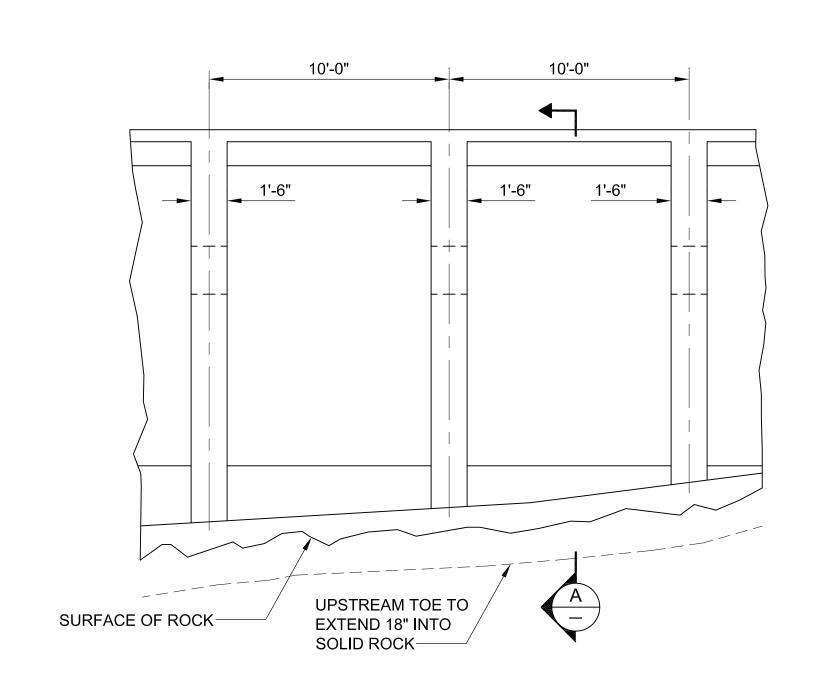


1" BARS SPACED AIR VENT @ 12" CENTER 1/2" BARS SPACED @ 24" CENTER-- RIB BEYOND -SURFACE OF ROCK

(EXISTING STILLING POOL DAM)

SECTION

SCALE: 1/4"=1'-0"

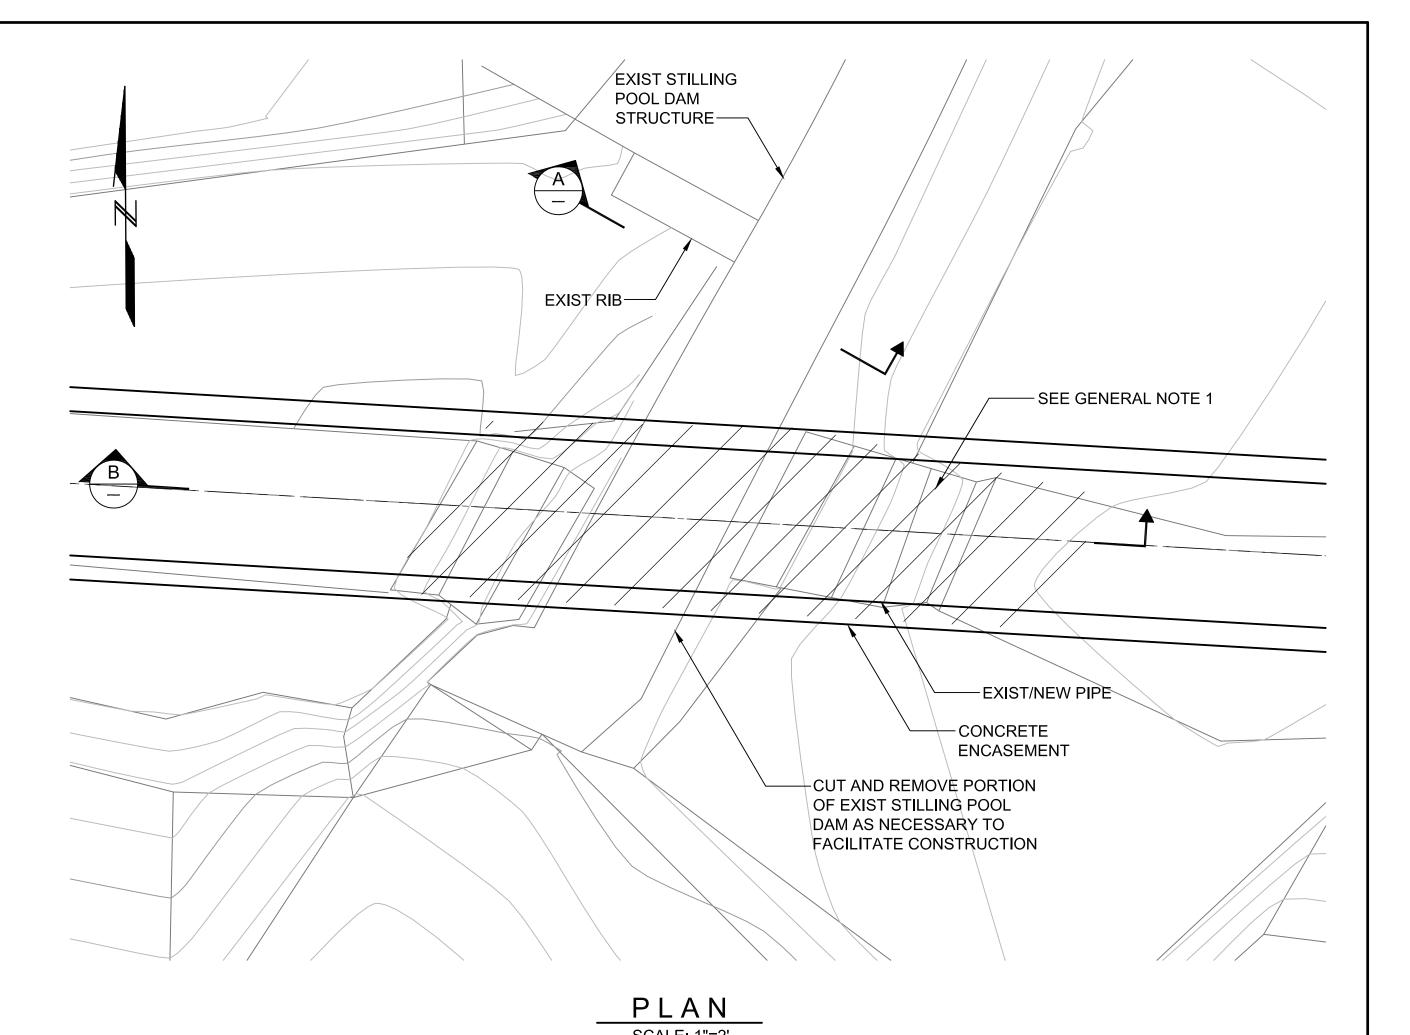


(EXISTING STILLING POOL DAM) **ELEVATION LOOKING EAST**

SCALE: 1/4"=1'-0"

GENERAL NOTES:

1. CONTRACTOR SHALL SUBMIT PLAN SHOWING DEMOLITION OF PORTION OF EXISTING STILLING POOL DAM TO BE REMOVED TO ENGINEER FOR APPROVAL 10 DAYS BEFORE BEGINNING THIS WORK. PLANS SHALL INCLUDE DEMOLITION SEQUENCING, SAFETY PROCEDURES, AND EQUIPMENT TO BE USED. PLAN SHALL BE STAMPED AND SIGNED BY A REGISTERED CIVIL ENGINEER IN STATE OF CALIFORNIA TO VERIFY THAT STRUCTURAL STABILITY OF REMAINING STRUCTURE IS NOT NEGATIVELY IMPACTED BY REMOVED PORTION OF STRUCTURE.

2. CONTRACTOR SHALL SUBMIT STRUCTURAL CALCULATIONS, INCLUDING SEISMIC, AND DRAWINGS FOR PORTION OF STILLING POOL DAM TO BE REPLACED IN-KIND AND IN ACCORDANCE WITH THIS DRAWING. CALCULATIONS AND DRAWINGS SHALL BE SUBMITTED TO ENGINEER 10 DAYS PRIOR TO BEGINNING DEMOLITION WORK.

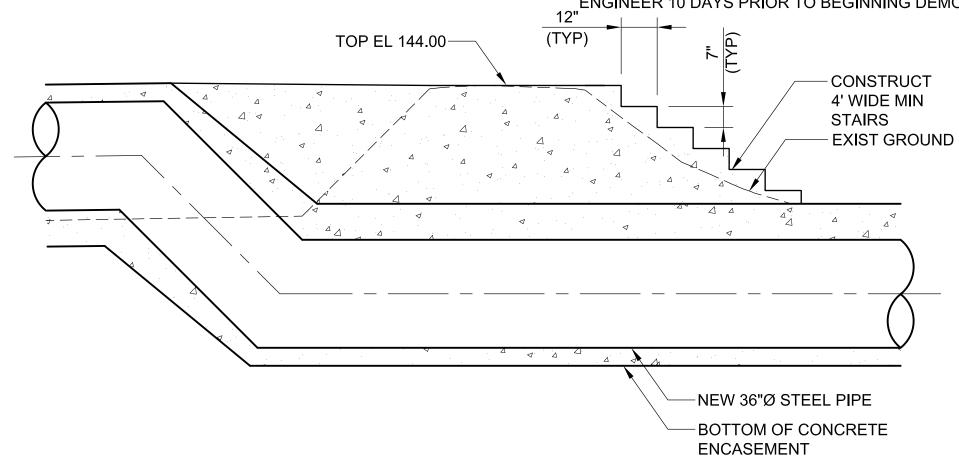

SECTION SCALE: 3/8"=1'-0"



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- ALL CONCRETE SHOWN ON THIS DRAWING SHALL BE STRUCTURAL CONCRETE WHICH SHALL DEVELOP A MINIMUM COMPRESSIVE STRENGTH OF 4,000 PSI AT 28 DAYS, UNLESS OTHERWISE NOTED.
- 2. ALL REINFORCING STEEL SHALL BE DEFORMED BARS CONFORMING TO THE REQUIREMENTS OF ASTM A-615, GRADE 60, UNLESS OTHERWISE NOTED.
- 3. ALL DETAILING, FABRICATION AND PLACING OF REINFORCING STEEL SHALL BE IN ACCORDANCE WITH ACI-315. "MANUAL OF STANDARD PRACTICE FOR DETAILING REINFORCED CONCRETE STRUCTURES". LATEST EDITION.
- 4. THE FIRST AND LAST BARS SHALL START AND END A MAXIMUM OF ONE HALF OF THE ADJACENT BAR SPACING OR 3-INCHES, WHICHEVER IS LESS. FROM THE START OR END OF THE MEMBER.
- 5. ALL CONSTRUCTION JOINTS SHALL BE ROUGH AND THOROUGHLY CLEANED FOR BOND PRIOR TO PLACING CONCRETE.
- TOLERANCES FOR PLACING REINFORCING STEEL SHALL BE ± 3/8 INCH.
- DOWELS, PIPING, WATERSTOPS AND OTHER EMBEDS SHALL BE HELD SECURELY IN PLACE WHILE THE CONCRETE IS BEING POURED.
- 8. ALL GROUT SHALL BE NON-SHRINK, UNLESS OTHERWISE NOTED.
- 9. BAR SUPPORTS, SPACERS, AND OTHER ACCESSORIES ARE NOT SHOWN ON THE DESIGN DRAWINGS.
- 10. METAL CLIPS OR SUPPORTS SHALL NOT BE PLACED IN CONTACT WITH THE FORMS OR SUBGRADE. CONCRETE BLOCKS OR DOBIES SHALL BE IN SUFFICIENT NUMBERS TO SUPPORT THE BARS ON THE SUBGRADE WITHOUT SETTLEMENT. IN NO CASE SHALL SUCH SUPPORT BE CONTINUOUS.


- 11. DOWELS SHALL BE SET AND WIRED OR OTHERWISE HELD IN PLACE PRIOR TO PLACING CONCRETE. DOWELS SHALL NOT BE INSERTED INTO FRESHLY PLACED CONCRETE.
- 12. A MINIMUM CLEAR DISTANCE OF 2 INCHES SHALL BE MAINTAINED BETWEEN THE REINFORCING STEEL AND ALL PIPES, PIPE FLANGES OR OTHER METAL PARTS EMBEDDED IN THE CONCRETE.
- 13. ALL ITEMS EMBEDDED IN THE CONCRETE SHALL BE SPACED AT NO LESS THAN 4 TIMES THE OUTSIDE DIMENSION OF THE LARGEST ITEM. THE OUTSIDE DIMENSION SHALL NOT EXCEED ONE THIRD THE CONCRETE MEMBER THICKNESS.
- 14. UNLESS OTHERWISE SHOWN ON THE DRAWINGS, CONCRETE COVER FOR REINFORCING BARS SHALL BE AS FOLLOWS:


CONCRETE PLACED AGAINST EARTH......3"

FOR SURFACES IN CONTACT WITH WATER OR WEATHER AND FORMED SURFACES IN CONTACT WITH EARTH.......3"

FOR CONCRETE NOT EXPOSED TO WEATHER OR CONTACT WITH WATER OR EARTH......3"

15. UNLESS OTHERWISE NOTED, WHERE A SINGLE LAYER OF REINFORCING STEEL IS SHOWN, THE REINFORCING SHALL BE CENTERED.

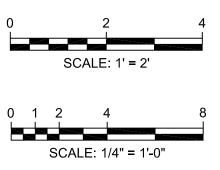

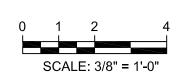

PLANS FOR THE INSTALLATION OF:

SWEETWATER AUTHORITY

SWEETWATER DAM

36-INCH RAW WATER PIPELINE REPLACEMENT


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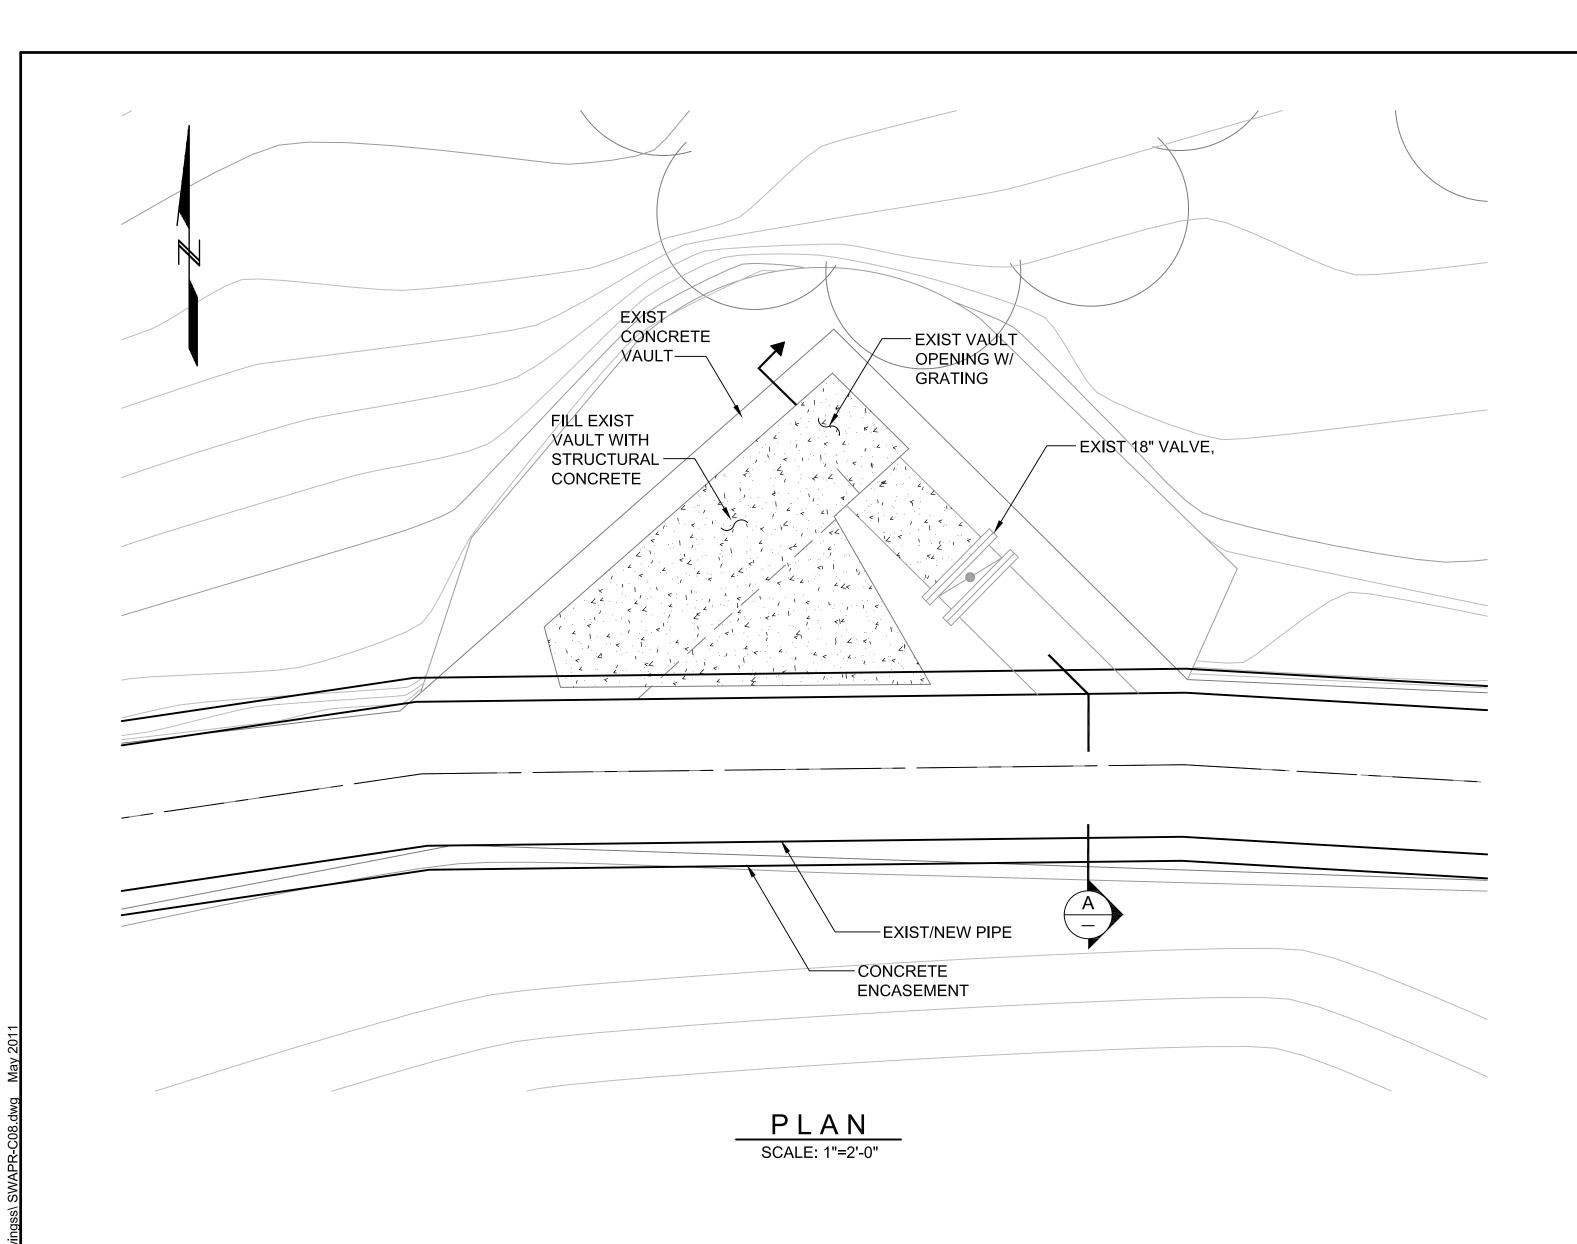
FOR BIDDING PURPOSES ONLY

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REV.	DATE	DESCRIPTION	BY	APPVD.	DESIGN BY: M. HARGROVE	SCALE: AS NOTED	GEI CON
Α					DRAWN BY: K. CHUNG	DATE: MAY 18, 2011	ENGINE




EXISTING STILLING POOL DAM CROSSING 1/4 SECTION W.O. # N/A ONSULTANTS INC. 5-18-2011 B.P. # 20104024 EER PE DATE SHEET CHECKED BY: M. ROZMAN DESIGN #: 20104024 **SWEETWATER AUTHORITY** 5-18-2011 10 OF 18 AS CONSTRUCTED: PAVEMENT#: N/A APPROVED DATE




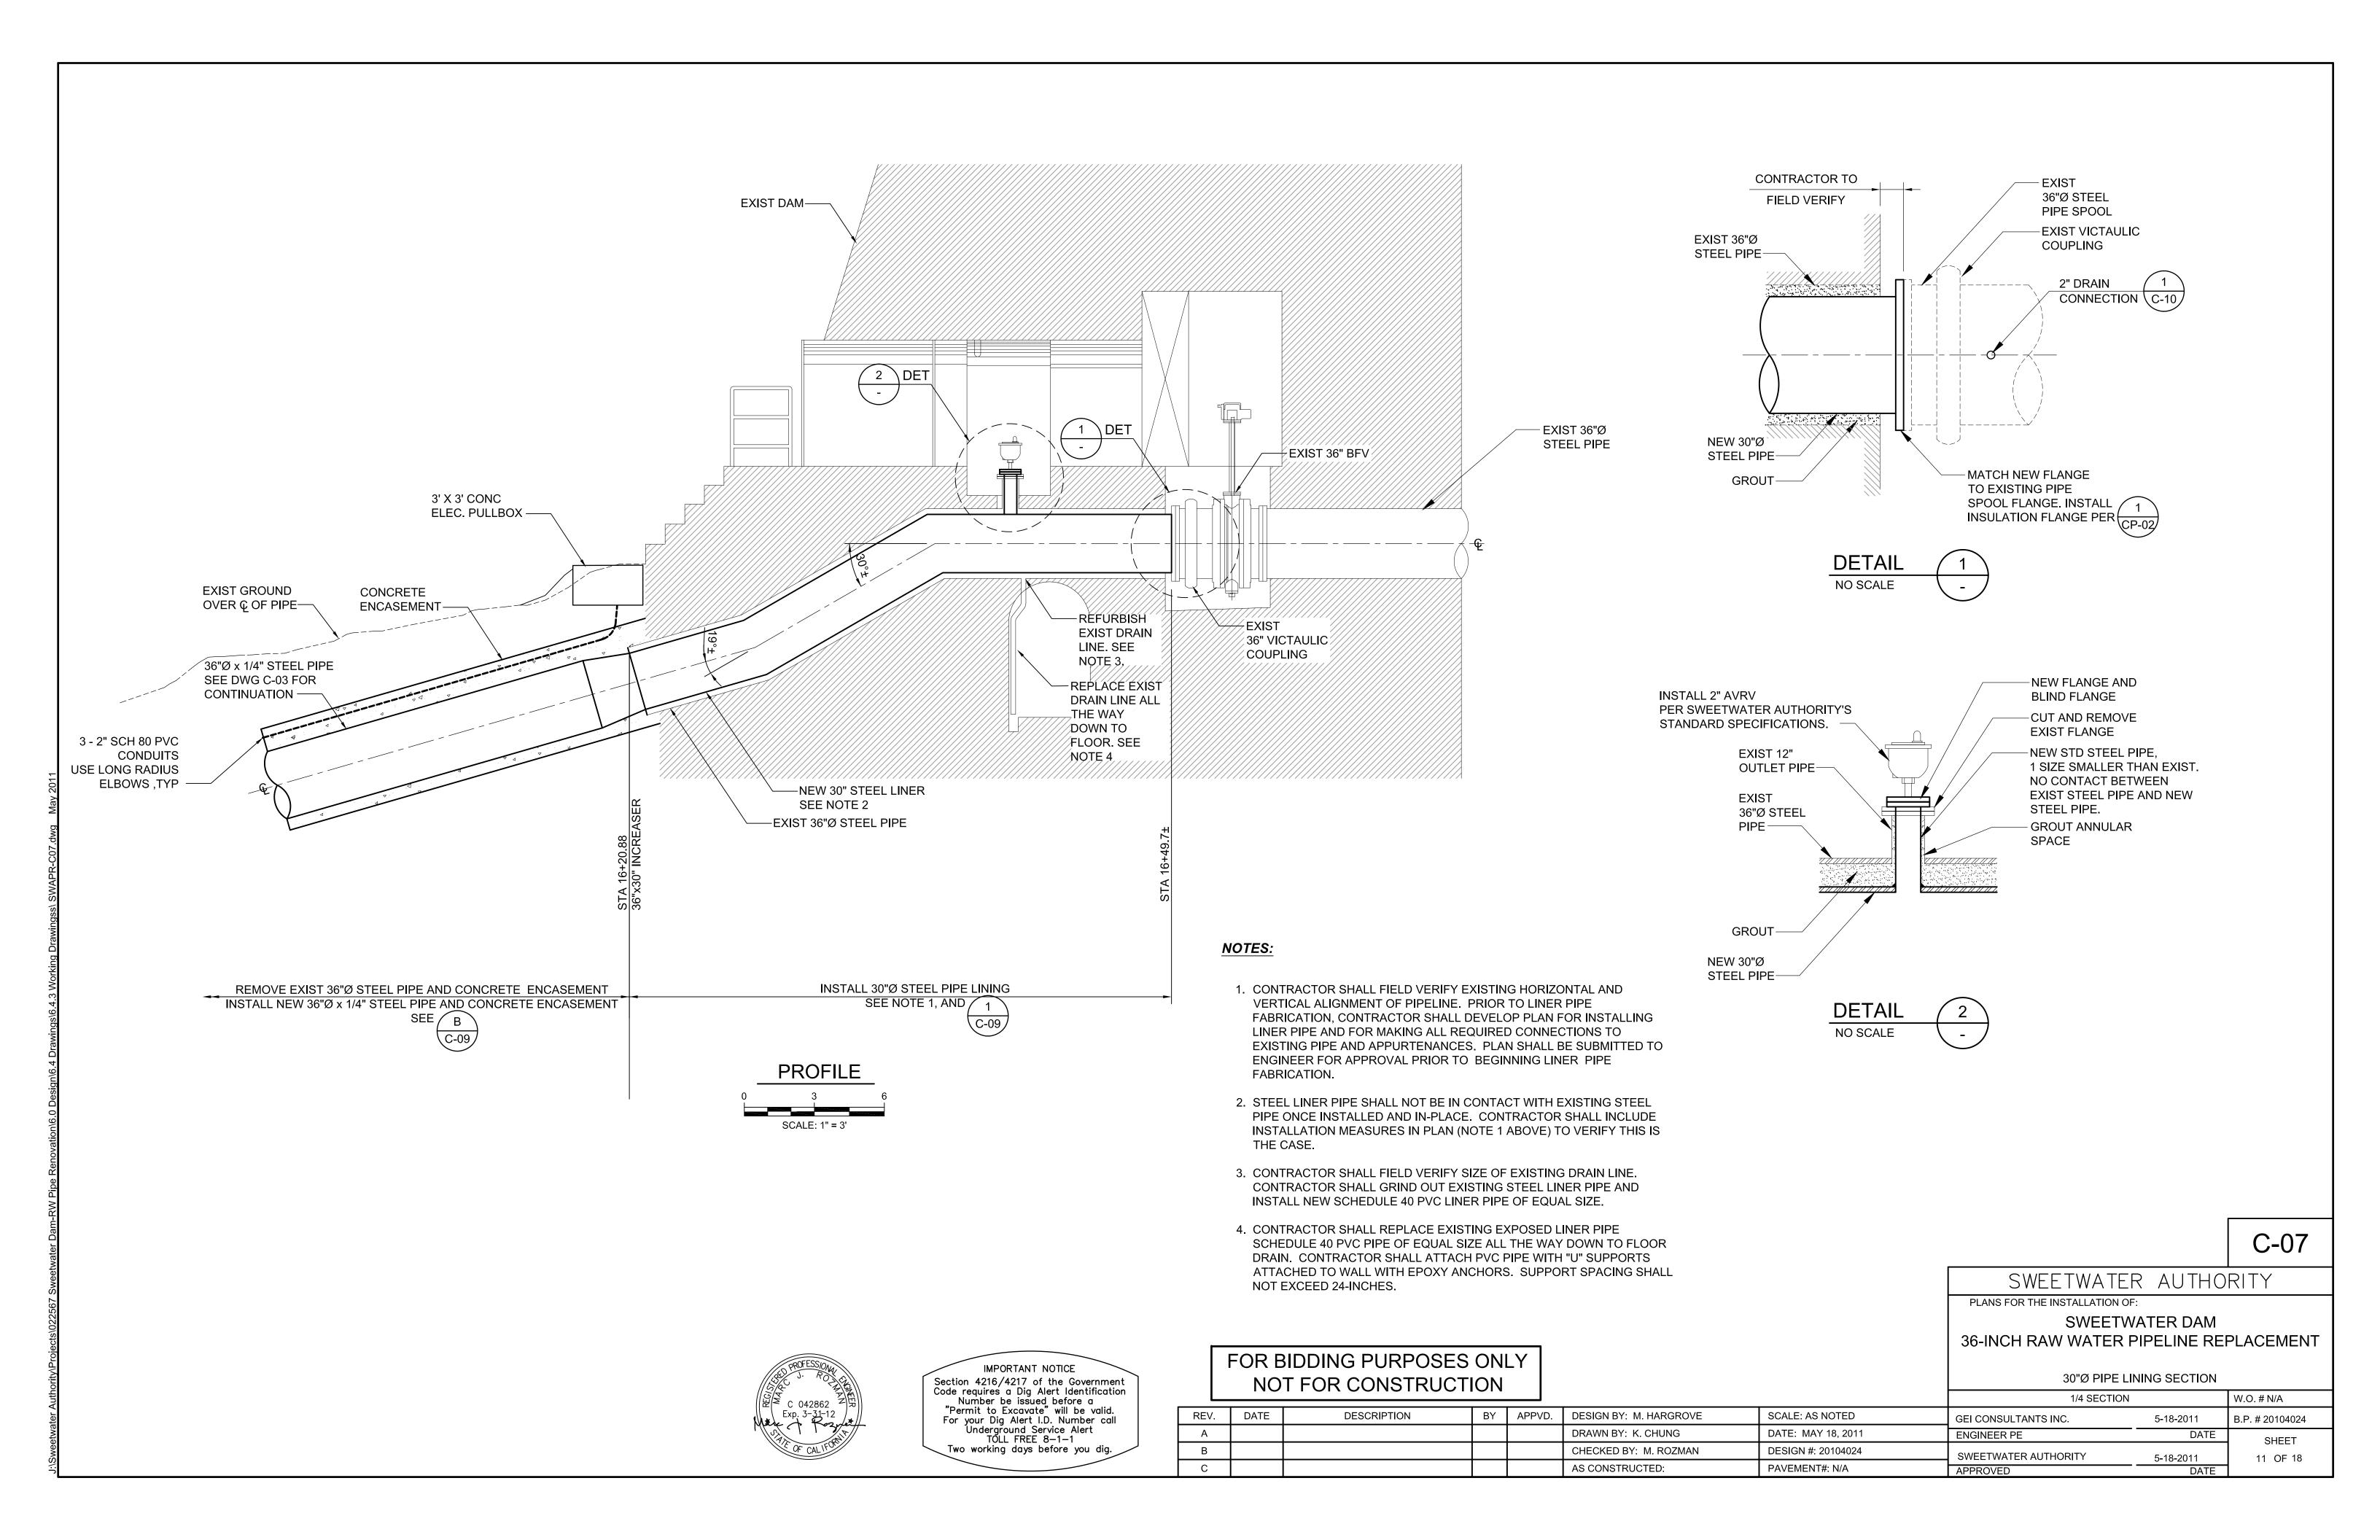


1. FOR LOCATION OF BLOWOFF INSTALLATION, SEE DWG C-02.

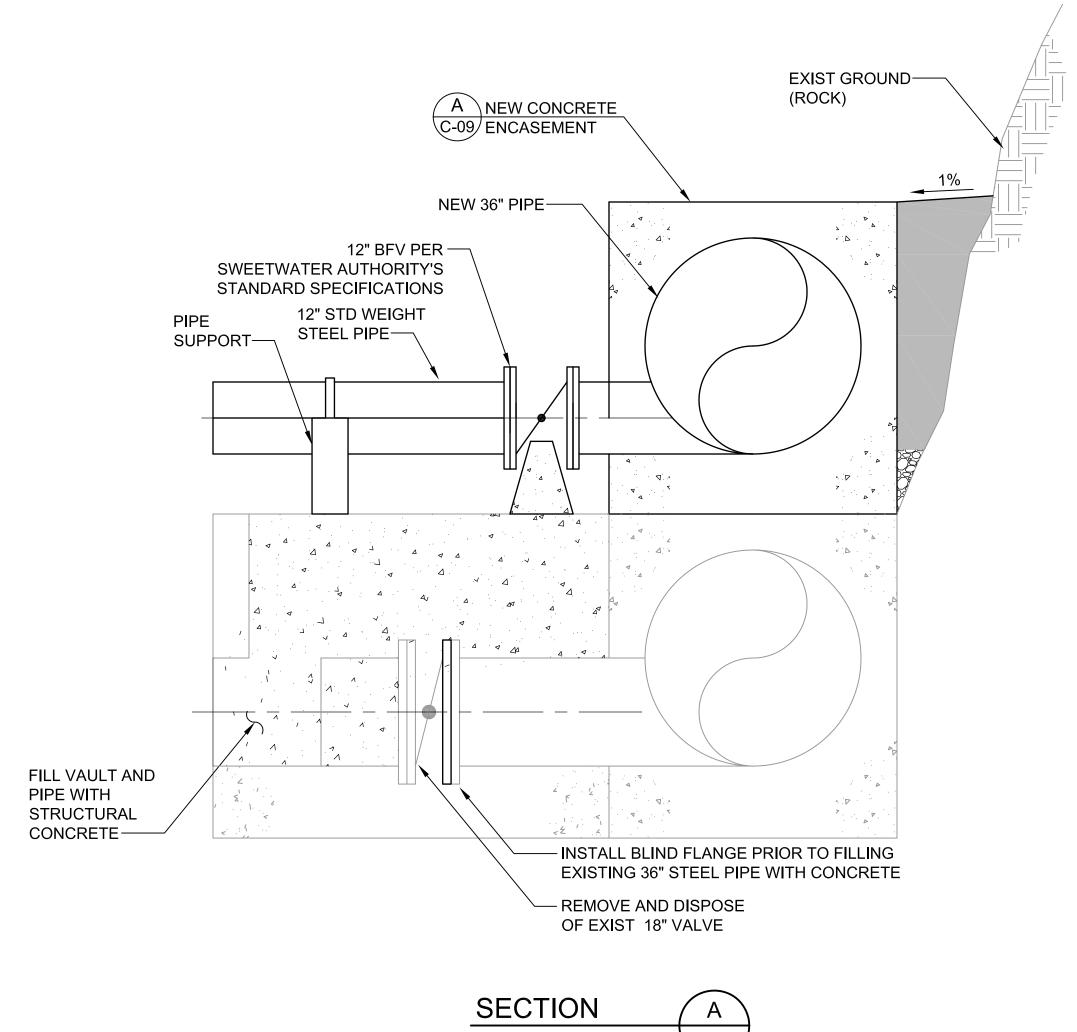

AT STA 11+40 SCALE: 3/4"=1'-0"

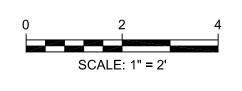

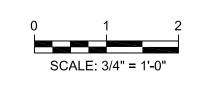

C-08

SWEETWATER AUTHORITY

PLANS FOR THE INSTALLATION OF:

SWEETWATER DAM 36-INCH RAW WATER PIPELINE REPLACEMENT

EXISTING BLOWOFF/VAULT ABANDONMENT AND NEW BLOWOFF INSTALLATION


1/4 SECTION		W.O. # N/A
GEI CONSULTANTS INC.	5-18-2011	B.P. # 20104024
ENGINEER PE	DATE	SHFFT
SWEETWATER AUTHORITY	5-18-2011	12 OF 18
APPROVED	DATE	



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В					CHECKED BY: M. ROZMAN	DESIGN #: 20104024	SWEETWATER AUTHORITY	5-18-2011	12 OF 18
С					AS CONSTRUCTED:	PAVEMENT#: N/A	APPROVED	DATE	12 01 10



REINFORCED CONCRETE NOTES:

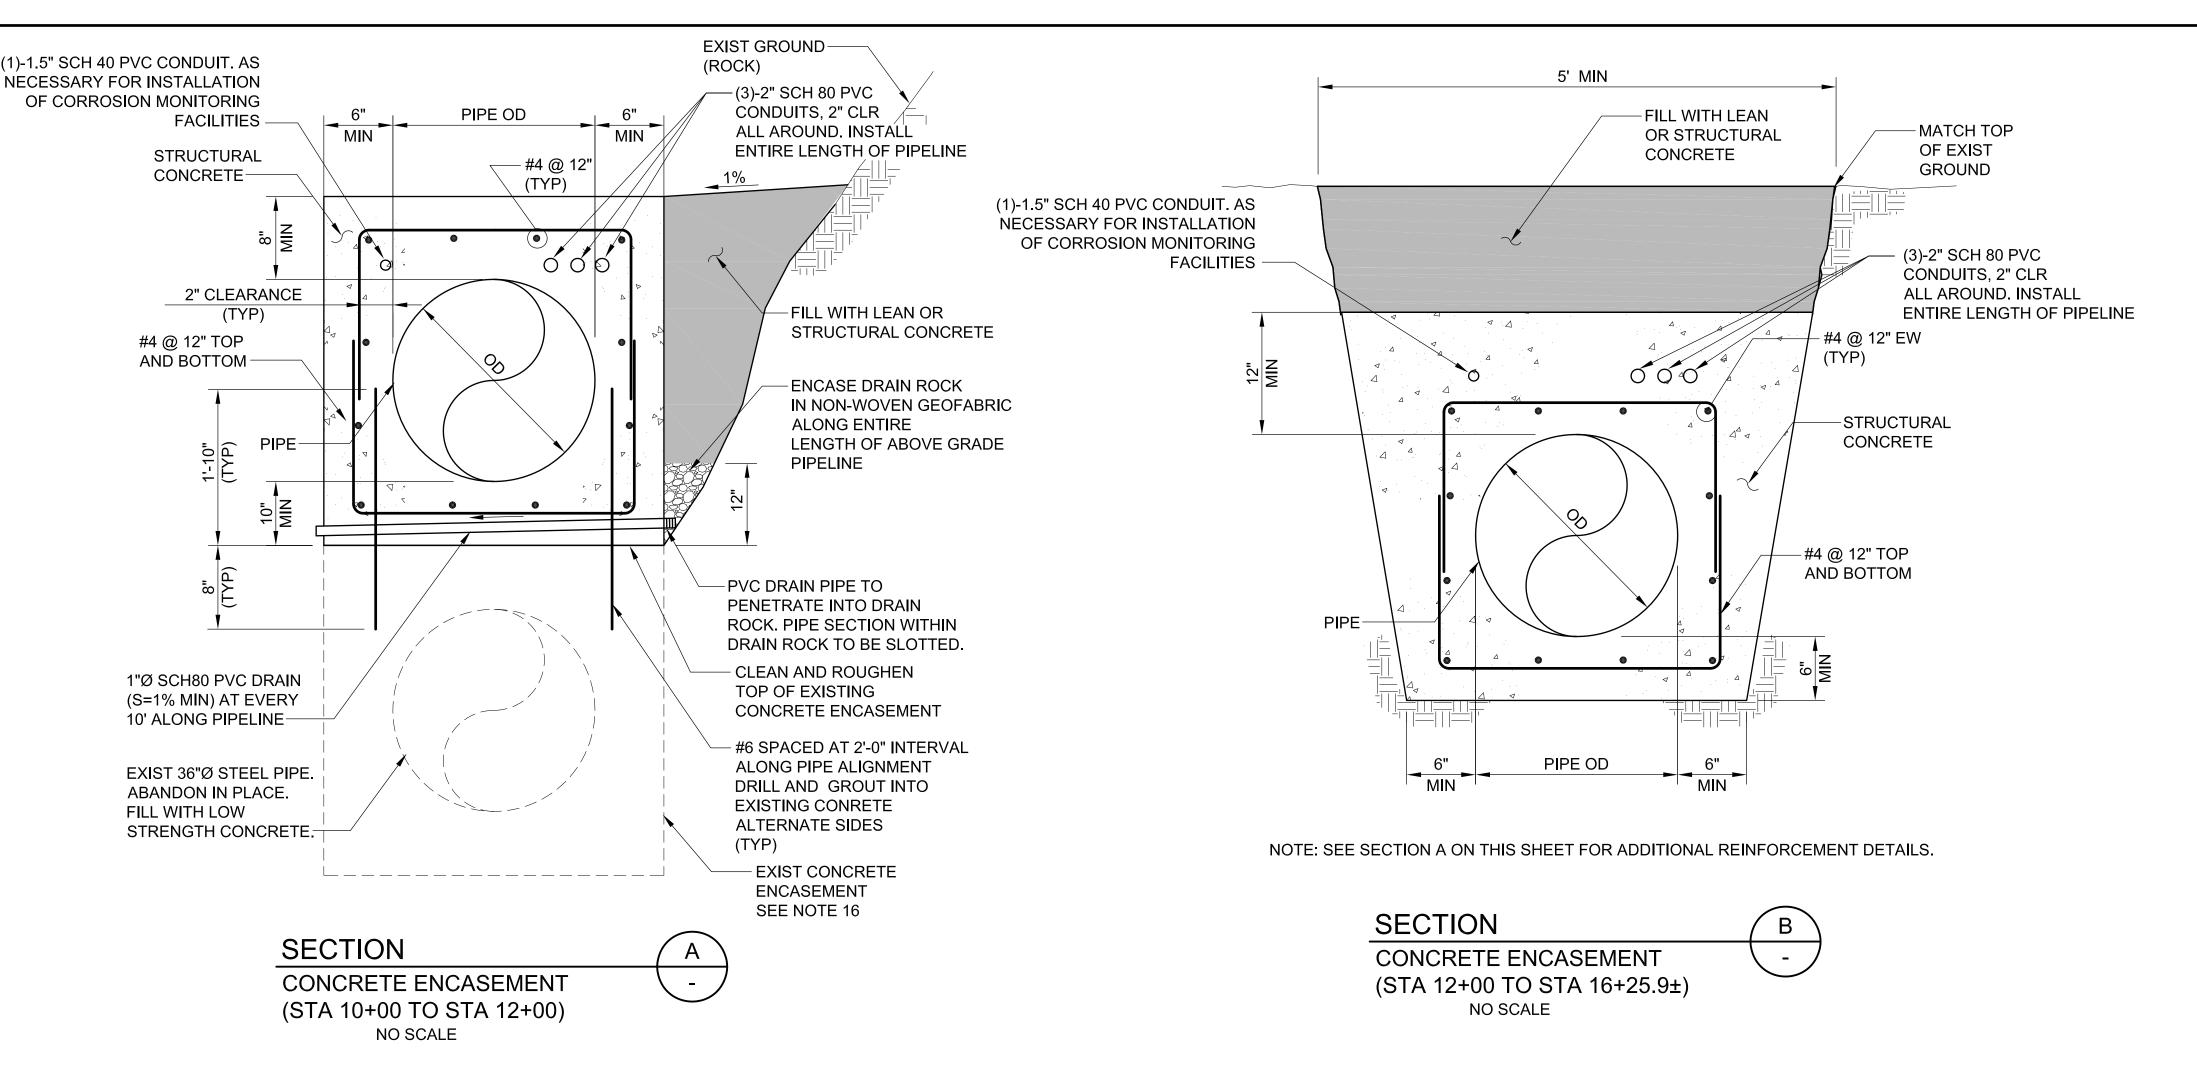- 1. ALL CONCRETE SHOWN ON THIS DRAWING SHALL BE STRUCTURAL CONCRETE WHICH SHALL DEVELOP A MINIMUM COMPRESSIVE STRENGTH OF 4,000 PSI AT 28 DAYS, UNLESS OTHERWISE NOTED.
- 2. ALL REINFORCING STEEL SHALL BE DEFORMED BARS CONFORMING TO THE REQUIREMENTS OF ASTM A-615, GRADE 60, UNLESS OTHERWISE NOTED.
- 3. ALL DETAILING, FABRICATION AND PLACING OF REINFORCING STEEL SHALL BE IN ACCORDANCE WITH ACI-315, "MANUAL OF STANDARD PRACTICE FOR DETAILING REINFORCED CONCRETE STRUCTURES", LATEST EDITION.
- 4. THE FIRST AND LAST BARS SHALL START AND END A MAXIMUM OF ONE HALF OF THE ADJACENT BAR SPACING OR 3-INCHES, WHICHEVER IS LESS, FROM THE START OR END OF THE MEMBER.
- 5. ALL CONSTRUCTION JOINTS SHALL BE ROUGH AND THOROUGHLY CLEANED FOR BOND PRIOR TO PLACING CONCRETE.
- 6. TOLERANCES FOR PLACING REINFORCING STEEL SHALL BE ± 3/8 INCH.
- 7. DOWELS, PIPING, WATERSTOPS AND OTHER EMBEDS SHALL BE HELD SECURELY IN PLACE WHILE THE CONCRETE IS BEING POURED.
- 8. ALL GROUT SHALL BE NON-SHRINK, UNLESS OTHERWISE NOTED.
- 9. BAR SUPPORTS, SPACERS, AND OTHER ACCESSORIES ARE NOT SHOWN ON THE DESIGN DRAWINGS.
- 10. METAL CLIPS OR SUPPORTS SHALL NOT BE PLACED IN CONTACT WITH THE FORMS OR SUBGRADE. CONCRETE BLOCKS OR DOBIES SHALL BE IN SUFFICIENT NUMBERS TO SUPPORT THE BARS ON THE SUBGRADE WITHOUT SETTLEMENT. IN NO CASE SHALL SUCH SUPPORT BE CONTINUOUS.

- 11. DOWELS SHALL BE SET AND WIRED OR OTHERWISE HELD IN PLACE PRIOR TO PLACING CONCRETE. DOWELS SHALL NOT BE INSERTED INTO FRESHLY PLACED CONCRETE.
- 12. A MINIMUM CLEAR DISTANCE OF 2 INCHES SHALL BE MAINTAINED BETWEEN THE REINFORCING STEEL AND ALL PIPES, PIPE FLANGES OR OTHER METAL PARTS EMBEDDED IN THE CONCRETE.
- 13. ALL ITEMS EMBEDDED IN THE CONCRETE SHALL BE SPACED AT NO LESS THAN 4 TIMES THE OUTSIDE DIMENSION OF THE LARGEST ITEM. THE OUTSIDE DIMENSION SHALL NOT EXCEED ONE THIRD THE CONCRETE MEMBER THICKNESS.
- 14. UNLESS OTHERWISE SHOWN ON THE DRAWINGS, CONCRETE COVER FOR REINFORCING BARS SHALL BE AS FOLLOWS:

CONCRETE PLACED AGAINST EARTH......3"

FOR SURFACES IN CONTACT WITH WATER OR WEATHER AND FORMED SURFACES IN CONTACT WITH EARTH......3"

FOR CONCRETE NOT EXPOSED TO WEATHER OR CONTACT WITH WATER OR EARTH......3"

- 15. UNLESS OTHERWISE NOTED, WHERE A SINGLE LAYER OF REINFORCING STEEL IS SHOWN, THE REINFORCING SHALL BE CENTERED.
- 16. SWEETWATER AUTHORITY WILL PERFORM CONCRETE CORINGS AND TESTING ON EXISTING CONCRETE ENCASEMENT AT BEGINNING OF PIPELINE SHUTDOWN.



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FOR BIDDING PURPOSES ONLY NOT FOR CONSTRUCTION

	110	T TON CONSTRUCT	1011				1/4 SECTION		W.O. # N/A
REV.	DATE	DESCRIPTION	BY	APPVD.	DESIGN BY: M. HARGROVE	SCALE: AS NOTED	GEI CONSULTANTS INC.	5-18-2011	B.P. # 20104024
Α					DRAWN BY: K. CHUNG	DATE: MAY 18, 2011	ENGINEER PE	DATE	SHEET
В					CHECKED BY: M. ROZMAN	DESIGN #: 20104024	SWEETWATER AUTHORITY	5-18-2011	13 OF 18
С					AS CONSTRUCTED:	PAVEMENT#: N/A	APPROVED	DATE	13 01 10


- EXIST 36"Ø STEEL PIPE FILL ANNULAR SPACE WITH GROUT -30"Ø x 1/4" STEEL PIPE

DETAIL STEEL PIPE LINER (STA 16+25.85 TO STA 16+49.7±)

NO SCALE


C-09

SWEETWATER AUTHORITY PLANS FOR THE INSTALLATION OF: SWEETWATER DAM 36-INCH RAW WATER PIPELINE REPLACEMENT PIPE ENCASEMENT AND LINING DETAILS

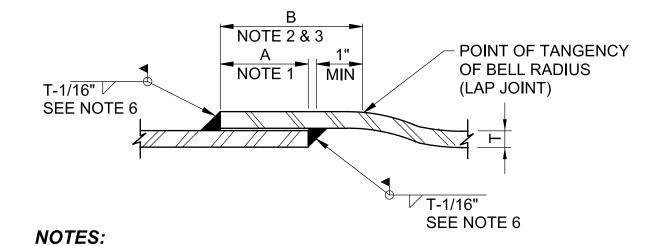


- 1. DIMENSION "A" CORRESPONDS TO THE COMPLETED JOINT OVERLAP AFTER WELDING. DIMENSION "A" IS THE GREATER OF 3 INCHES OR 5T, MINIMUM FOR STANDARD JOINTS. INCREASE DIMENSION "A" FOR SPECIAL TEMPERATURE CONTROL JOINTS AS FURTHER DISCUSSED IN NOTE 3.
- 2. PROVIDE THE MINIMUM OVERLAP DIMENSION "A" AND MAINTAIN THE INDICATED HOLDBACK FOR THE WELD AS REQUIRED FOR THE MINIMUM DIMENSION "B" FOR STANDARD JOINTS.
- 3. INCREASE DIMENSION "B" BY 3 INCHES FOR SPECIAL TEMPERATURE CONTROL JOINTS AS FURTHER DISCUSSED. AT THE TIME OF INSTALLATION AND PRIOR TO WELDING, INSERT THE SPIGOT INTO THE LENGTHENED BELL TO PROVIDE "A"+3 INCHES MINIMUM OVERLAP. SEE SPECIFICATIONS FOR SPECIAL TEMPERATURE CONTROL JOINT WELDING REQUIREMENTS.
- 4. CONFIGURATION FOR BELL AND SPIGOT LAP JOINTS SHOWN. CONFIGURATION FOR BUTT STRAP JOINTS ARE SIMILAR.
- 5. FABRICATE AND INSTALL JOINTS WITHIN THE TOLERANCES INDICATED. TOLERANCE REQUIREMENT APPLY TO BOTH WELDS AND TO BOTH STRAIGHT AND DEFLECTED JOINTS.
- 6. CONTRACTOR MAY USE EITHER INTERIOR OR EXTERIOR WELD OPTIONS.



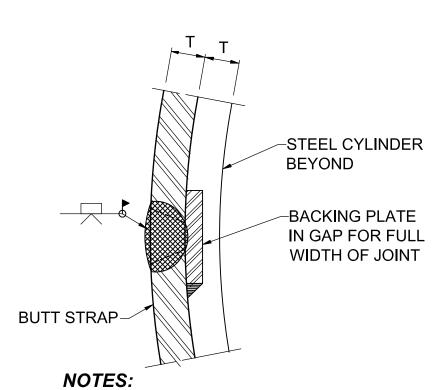


- 1. LINING AND COATINGS ARE NOT SHOWN FOR CLARITY.
- 2. LEVEL ENDS OF BACKING PLATE AS BUTT STRAP PRIOR TO WELDING OR BACK GOUGE AT CONTACT WITH ADJACENT CYLINDER PRIOR TO COMPLETING INSIDE FILLET WELD.



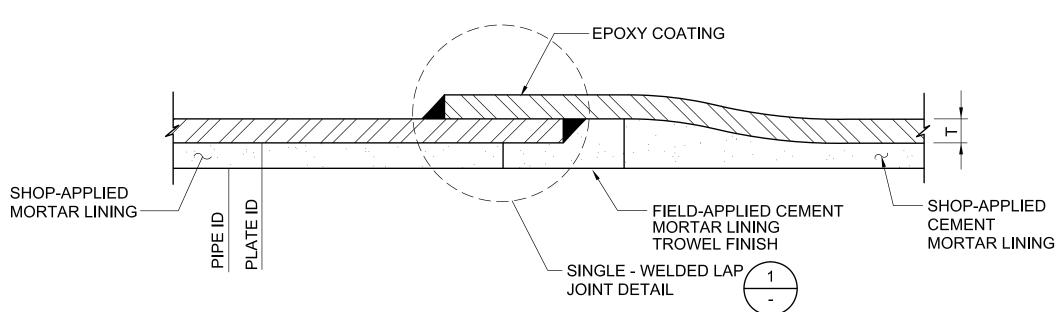

- 1. FOR INSIDE DIAMETER AND PLATE THICKNESS OF WELDED STEEL PIPE. SEE PLAN AND PROFILE DRAWINGS.
- 2. "T" INDICATES THE THICKNESS OF THE STEEL PLATE.

DETAIL JOINT COATING AND LINING AT LAP JOINTS

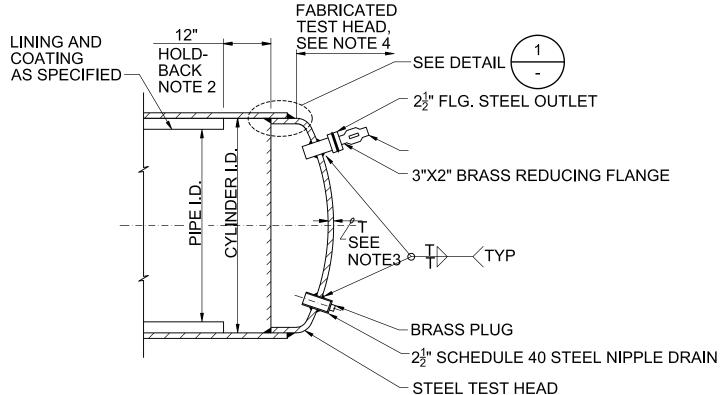

NOTES:

- 1. LINE AND COAT TEST HEAD AND PLAIN END WITH 3 MILS MINIMUM RUST INHIBITING
- 2. MINIMUM 8" HOLDBACK REQUIRED AFTER TEST HEAD CUT OFF.
- 3. WALL THICKNESS "T" SHALL BE THE SAME AS THE ADJOINING PIPE OR 3/8-INCH, WHICHEVER IS GREATER.
- 4. EXCEPT FOR WELDING ON OUTLETS, ALL WELDS ON FABRICATED TEST HEADS SHALL BE FULL PENETRATION BUTT WELDS. ALL BUTT WELDS SHALL BE 100% RADIOGRAPHY TESTED.

В






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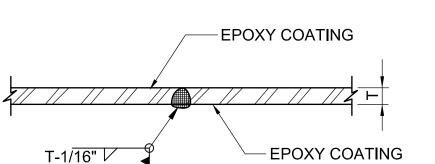
REV. Α



NOTES:

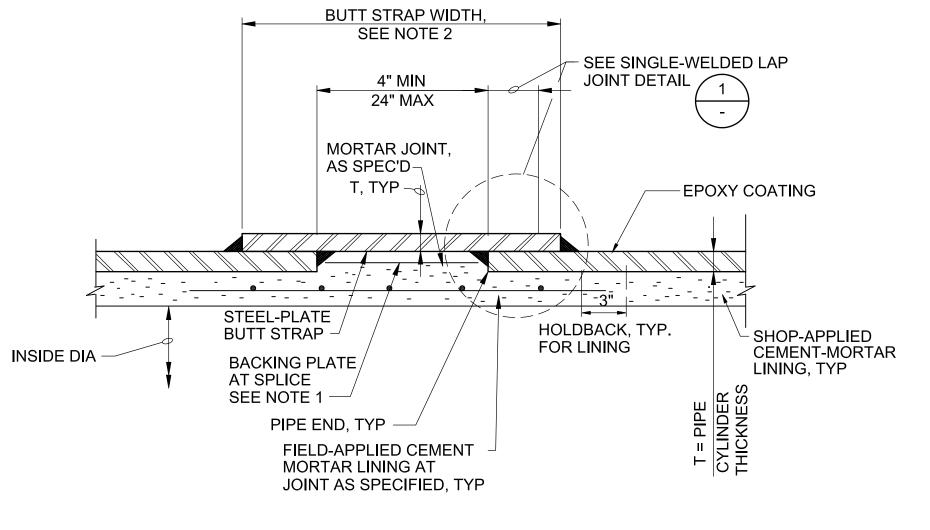- 1. FOR FIELD WELDING OF INDIVIDUAL BUTT STRAP PIECES TO EACH OTHER, SEE BUTT STRAP SPLICE DETAIL ON THIS DRAWING
- 2. UNLESS OTHERWISE NOTED, CONFORM BUTT STRAP WIDTH TO THE LIMITATIONS SHOWN FOR PIPE END SEPARATION AND OVERLAP REQUIREMENTS. THIS INCLUDES THE ADDITIONAL 3-INCH INCREASE IF A TEMPERATURE CONTROL JOINT IS REQUIRED AT A BUTT STRAP JOINT.









C-10

SWEETWATER AUTHORITY
PLANS FOR THE INSTALLATION OF:
SWEETWATER DAM
36-INCH RAW WATER PIPELINE REPLACEMENT


TYPICAL DETAILS - 1

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						1/4 SECTION		W.O. # N/A
DATE	DESCRIPTION	BY	APPVD.	DESIGN BY: M. HARGROVE	SCALE: AS NOTED	GEI CONSULTANTS INC.	5-18-2011	B.P. # 20104024
				DRAWN BY: K. CHUNG	DATE: MAY 18, 2011	ENGINEER PE	DATE	SHEET
				CHECKED BY: M. ROZMAN	DESIGN #: 20104024	SWEETWATER AUTHORITY	5-18-2011	14 OF 18
				AS CONSTRUCTED:	PAVEMENT#: N/A	APPROVED	DATE	14 01 10

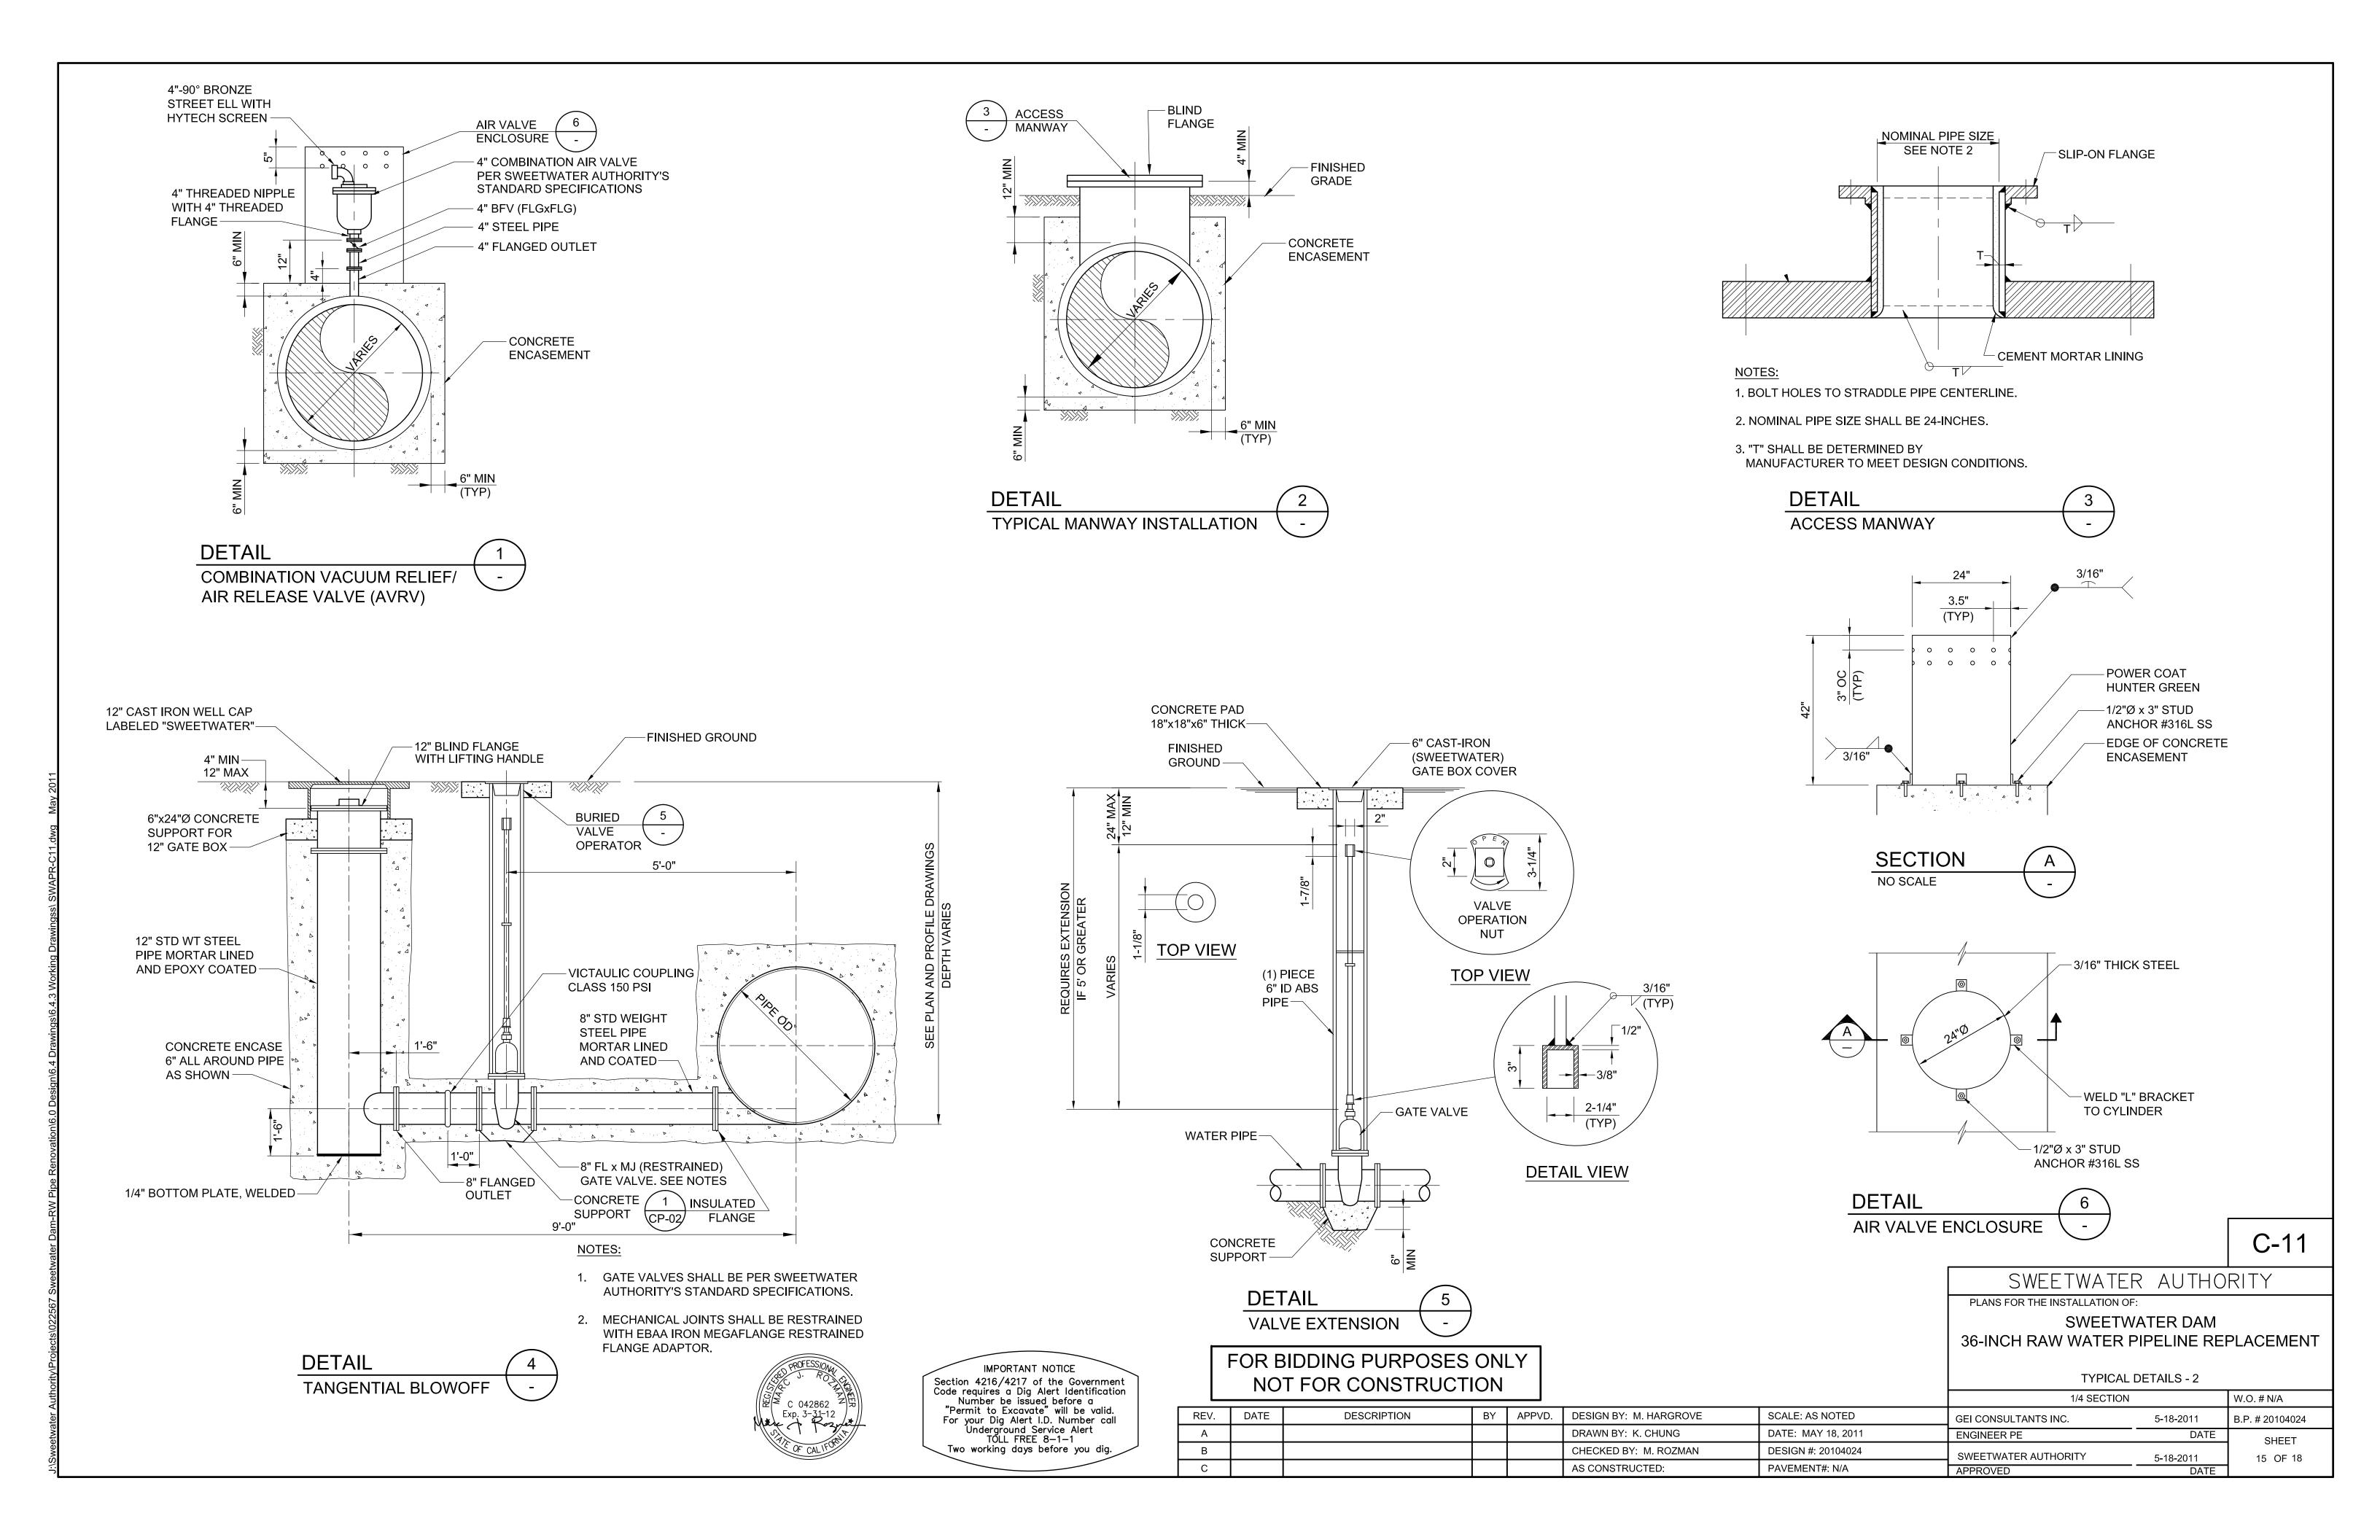


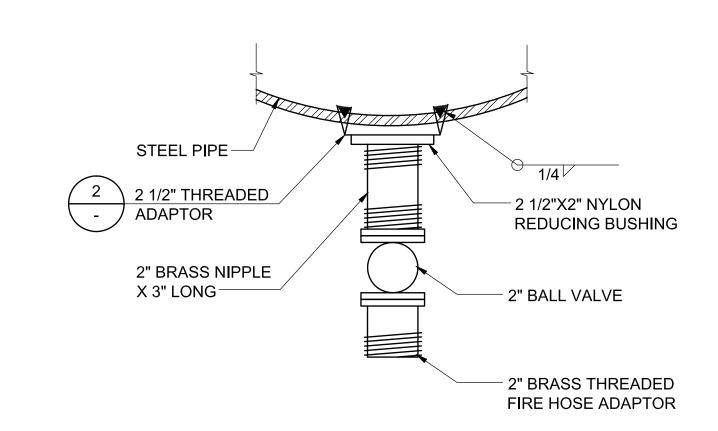



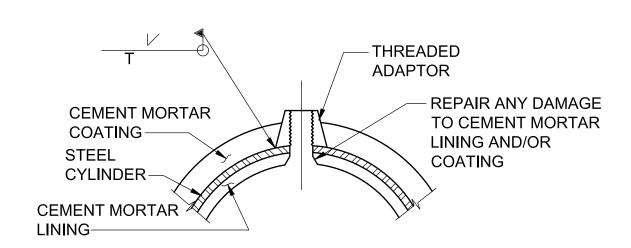



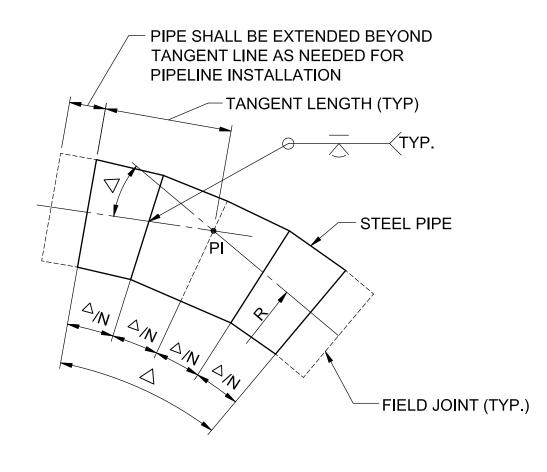

(THREE PIECE ELBOW SHOWN: N=4)

SCHEDULE FOR FABRICATED ELBOW								
BEND ANGLE	ELBOW USED	N						
0° < △ ≤ 15°	TWO-PIECE	2						
15° < △ ≤ 30°	THREE-PIECE	4						
30° < △ ≤ 45°	FOUR-PIECE	6						
45° < △ ≤ 90°	FIVE-PIECE	8						

ELBOW RADIU	JS
PIPE DIAMETER (NOM)	R (MIN)
24"	5'-0"
30"	6'-3"
36"	7'-6"
42"	8'-9"
48"	10'-0"
54"	11'-3"
78"	16'-3"

PROFESSIONAL J. RO SEC. 042862 Exp. 3-31-12 IMPORTANT NOTICE


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Two working days before you dig.

FOR BIDDING PURPOSES ONLY NOT FOR CONSTRUCTION

	C-12				
SWEETWATER AUTHO	RITY				
PLANS FOR THE INSTALLATION OF:					
SWEETWATER DAM 36-INCH RAW WATER PIPELINE REPLACEMEN					
JU-IINGLI NAVV VVALEN PIPELIIVE NEI					

TYPICAL DETAILS - 3

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REV.	DATE	DESCRIPTION	BY	APPVD.	DESIGN BY: M. HARGROVE	SCALE: AS NOTED	GEI CONSULTANTS INC.	5-18-2011	B.P. # 20104024
Α					DRAWN BY: K. CHUNG	DATE: MAY 18, 2011	ENGINEER PE	DATE	SHEET
В					CHECKED BY: M. ROZMAN	DESIGN #: 20104024	SWEETWATER AUTHORITY	5-18-2011	16 OF 18
С					AS CONSTRUCTED:	PAVEMENT#: N/A	APPROVED	DATE	10 01 10

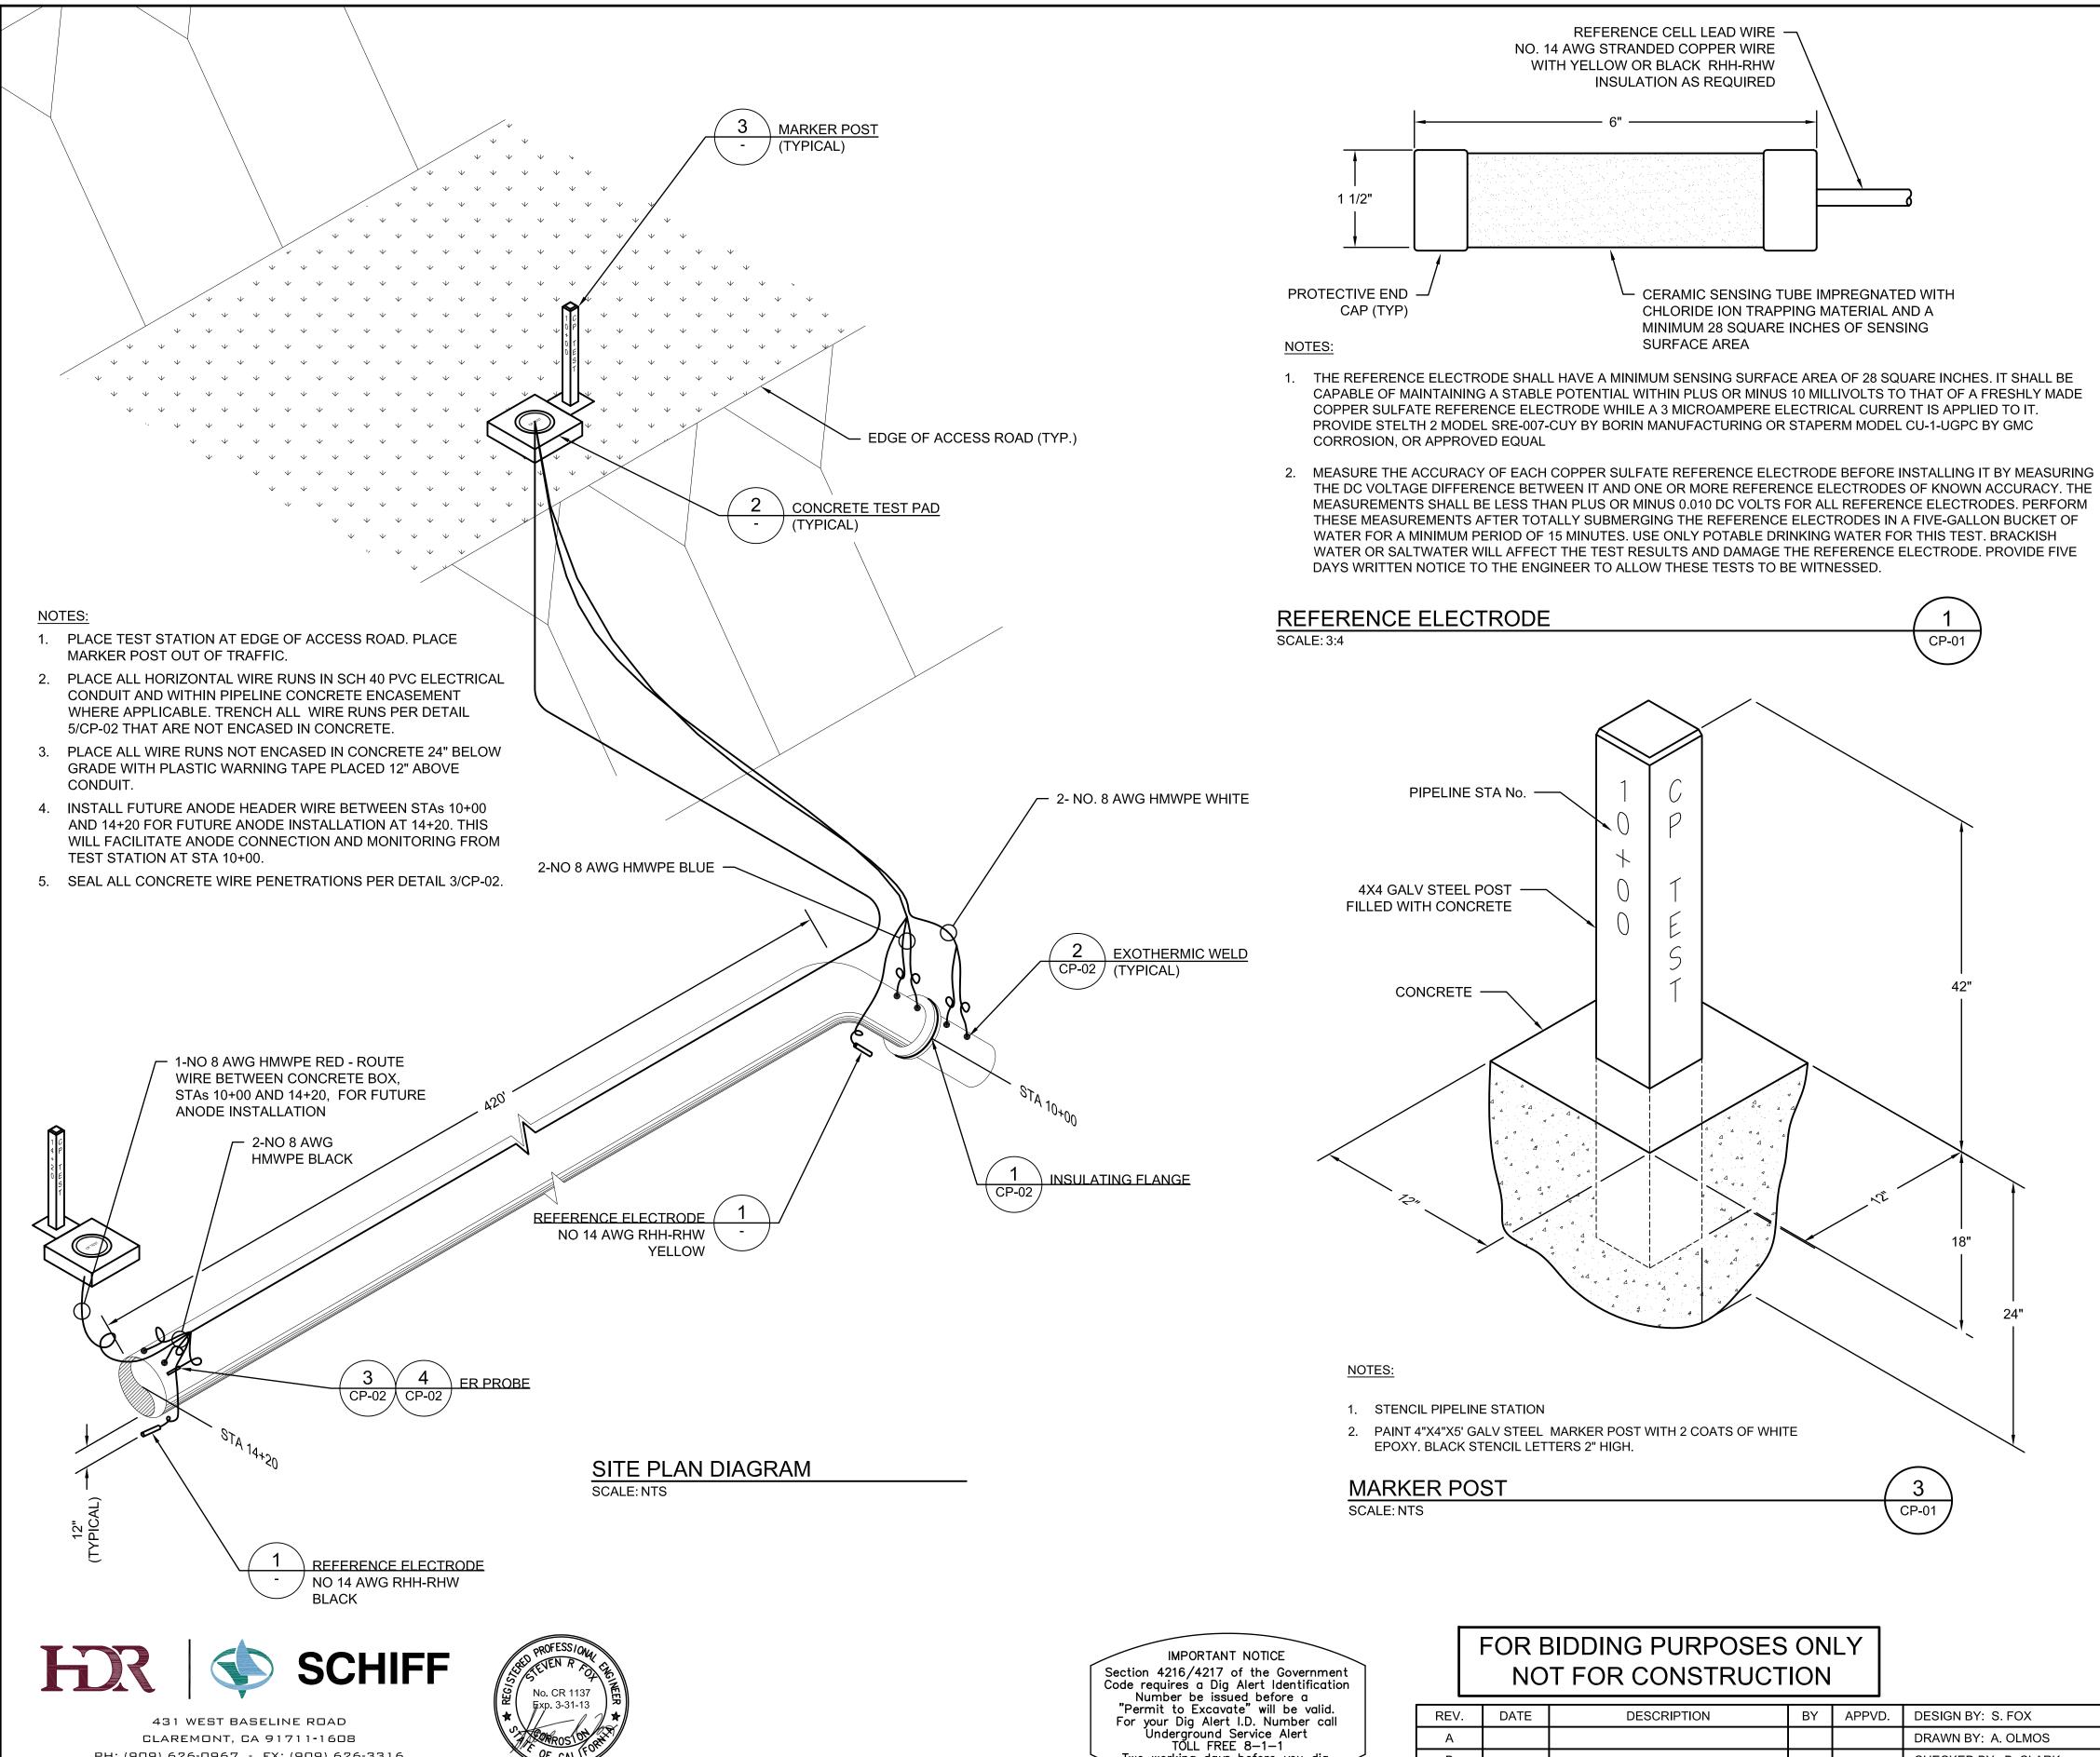

431 WEST BASELINE ROAD CLAREMONT, CA 91711-1608


PH: (909) 626-0967 - FX: (909) 626-3316

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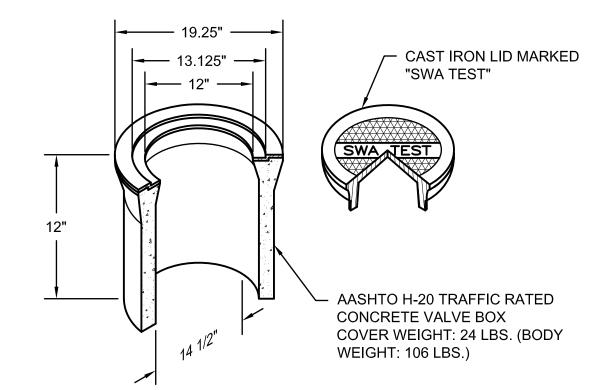
В

Two working days before you dig.



- 1. SLOPE CONCRETE PAD 2% ALL AROUND TO PREVENT WATER PONDING.
- 2. EDGE OF CONCRETE PAD SHALL BE 1 / 2" ABOVE FINISHED GRADE.

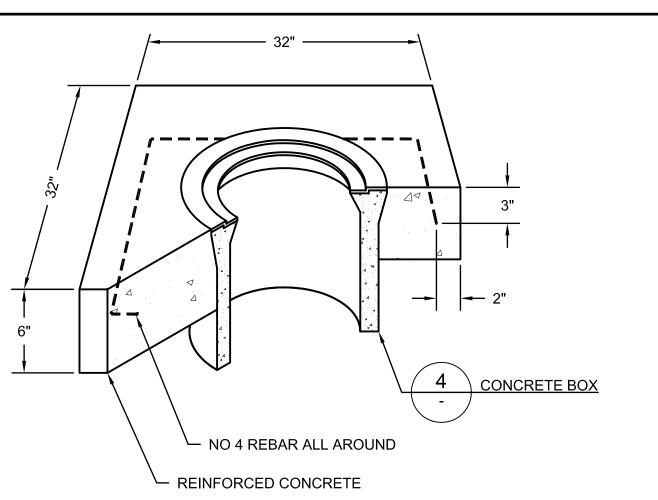CONCRETE TEST PAD SCALE: NTS



- 1. CONCRETE BODY, TRAFFIC RATED CONCRETE VALVE BOX, CHRISTY G8 OR EQUAL.
- 2. ALL WIRES SHALL HAVE 24" MIN. SLACK IN BOX.
- 3. BOTTOM OF TEST BOX SHALL BE NATIVE SOIL. DO NOT PLACE ROCK, GRAVEL OR SAND IN TEST BOX.
- 4. PROVIDE 32" SQ. x 6" THICK REINFORCED CONCRETE PAD AROUND TEST BOXES AT UNPAVED SITES.
- 5. AFFIX WIRE MARKERS PER DETAIL 6/CP-02

CONCRETE BOX SCALE: NTS

CP-01

CP-01


SWEETWATER AUTHORITY PLANS FOR THE INSTALLATION OF:

SWEETWATER DAM

36-INCH RAW WATER PIPELINE REPLACEMENT

CORROSION MONITORING DETAILS - 1

						1/4 SECTION		W.O. # N/A
DATE	DESCRIPTION	BY	APPVD.	DESIGN BY: S. FOX	SCALE: AS NOTED	GEI CONSULTANTS, INC.	5/18/2011	B.P. # N/A
				DRAWN BY: A. OLMOS	DATE: MAY 18, 2011	ENGINEER PE	DATE	SHEET
				CHECKED BY: B. CLARK	DESIGN# 20104024	SWEETWATER AUTHORITY	5/18/2011	17 OF 18
				AS CONSTRUCTED:	PAVEMENT#: N/A	APPROVED	DATE	17 01 10

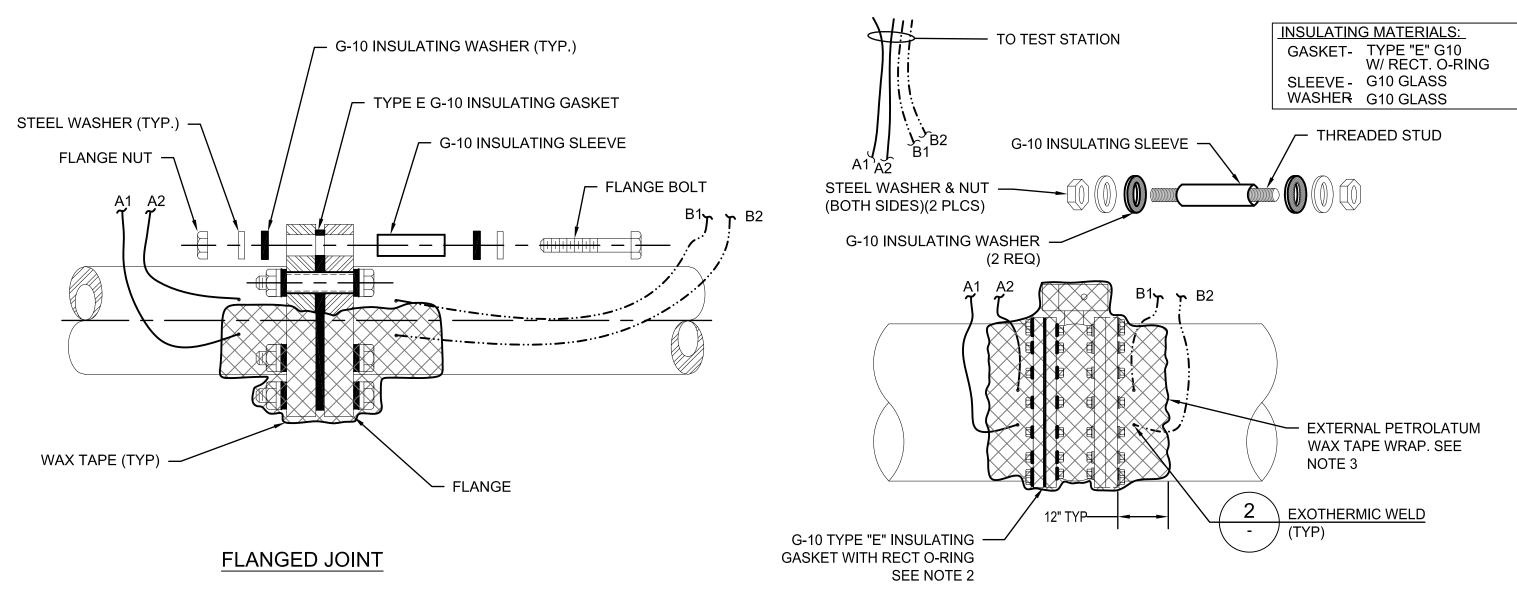


- 1. FULL LENGTH INSULATING SLEEVES REQUIRED AT ALL THRU-FLANGE BOLTS OR STUDS. HALF LENGTH SLEEVES REQUIRED AT THREADED BOLT HOLES AT VALVE BONNET AND BASE.
- 2. VALVE AND INSULATING FLANGE KIT TO BE ASSEMBLED BY THE CONTRACTOR AND TESTED BY ENGINEER PRIOR TO BURIAL. RE-TEST AFTER FINAL INSTALLATION. SEE SPECIFICATION SECTION 13 11 00.
- 3. BURIED INSULATING FLANGES ARE TO WRAPPED WITH WAX TAPE. DAMAGED COATINGS WHERE INSULATING FLANGES ARE INSTALLED IN VAULTS ARE TO BE REPAIRED PER PROJECT COATING SPECIFICATIONS.
- 4. COATING FOR THE INTERNAL LINING OF THE PIPELINE AT INSULATING FLANGES SHALL BE A TWO PART, SMOOTH, THIXOTROPIC LIQUID EPOXY CONSISTING OF 100 PERCENT SOLID. COATING SHALL BE RAVEN AQUATAPOXY A-6 EPOXY COATING AS MANUFACTURED BE RAVEN LININGS CORPORATION, OR APPROVED EQUAL.
- 5. SEE SITE PLAN ON CP-01 FOR TEST BOX PLACEMENT.

1 SQ IN SENSING AREA

MATCH PIPE MATERIAL

WITH ELEMENT TO

PH: (909) 626-0967 - FX: (909) 626-3316

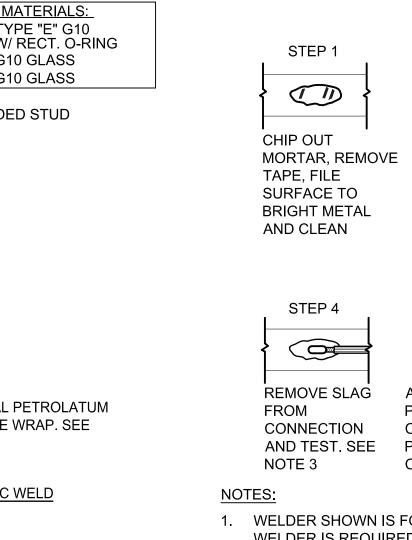

STEP 1

AND CLEAN OPERATOR, IGNITE STARTING POWDER STEP 4 REMOVE SLAG APPLY 2 COATS **COAT WITH A** FROM PRIMER AND COVER BITUMINOUS COMPOUND CONNECTION CONNECTION WITH AND FILL VOID IN AND TEST. SEE PRE-FORMED WELD MORTAR WITH GROUT NOTE 3 SEE NOTE 4

STRIP INSULATION


FROM WIRE

STEP 3

HOLD WELDER FIRMLY

WITH OPENING AWAY FROM

- 1. WELDER SHOWN IS FOR HORIZONTAL SURFACES; FOR VERTICAL SURFACES SIDE WELDER IS REQUIRED.
- 2. ATTACH 1 WIRE PER WELD. ALL WIRE WELDS SHALL BE 6 INCHES APART, MINIMUM.
- 3. ALL WELDS SHALL BE TESTED BY STRIKING THE WELD WITH A 2 LB HAMMER WHILE PULLING FIRMLY ON WIRE. ANY WELDS BROKEN OR LOOSENED SHALL BE RE-WELDED AND RE-TESTED. THE SURFACE MUST BE RE-GROUND AND CLEAN BEFORE RE-WELDING. ALL WELD SLAG SHALL BE REMOVED FROM THE WELD.
- 4. ALL EXPOSED METAL (STRUCTURE, WIRE, & WELD) WITHIN A 3-INCH RADIUS OF WELD SHALL BE COVERED WITH 2 COATS OF PRIMER AND AN ELASTOMERIC WELD CAP.
- 5. APPLY A GENEROUS COAT OF BITUMEN OVER WELD CAP AND EXPOSED METAL UP TO 3 INCHES BEYOND CAP.

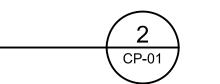

INSULATION A MINIMUM OF 1-INCH.

2. SEAL AROUND THE WIRE PENETRATION FROM THE CEMENT-MORTAR WITH A COAL-TAR EPOXY. OVERLAP THE CEMENT-MORTAR COATING AND WIRE

1. PLACE THE ELECTRICAL RESISTANCE PROBE AT THE 10:00 POSITION.

— ELECTRICAL RESISTANCE PROBE ATTACH TO STEEL CAN OR

SPIGOT USING EPOXY ADHESIVE

3. ROUTE CABLE TO CTS AT STATION 10+00

SEAL WIRE PENETRATION -WITH COAL-TAR EPOXY


FIELD APPLIED

CEMENT-MORTAR



CP-01

INSULATING FLANGE CP-01

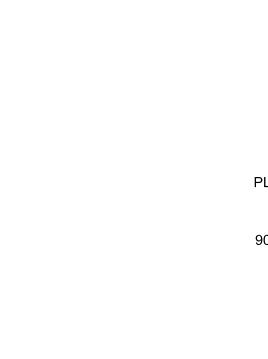

- 6 PIN MS-STYLE CONNECTOR

STANDARD CABLE

GROUND LEAD

- MOLDED ENCASEMENT

BUTTERFLY VALVE

LOW PROFILE ER PROBE SCALE: NTS CP-01

RIBBON

CABLE

1/10" THICK

LENGTH AS

REQUIRED


- SEE NOTE 1 PLASTIC WARNING TAPE 90% RELATIVE COMPACTION DECOMPOSED GRANITE WIRE CONDUIT(S) SIZE AND NUMBER WILL

EXOTHERMIC WELD

SCALE: NTS

1. TRENCH WIDTH SHALL BE A MINIMUM OF 12" BUT NO GREATER THAN 24".

TRENCH CP-01 SCALE: 1:16

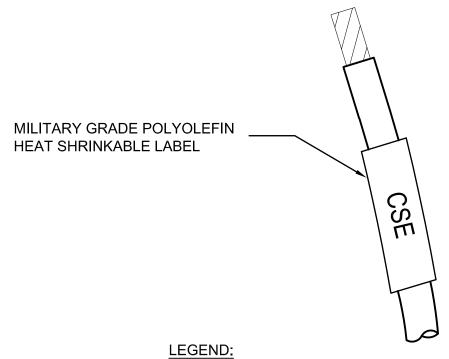

PIPELEAD AT STA 14+20 PL 14+20 PL 10+00 W PIPELEAD AT STA 10+00 W PL 10+00 E PIPELEAD AT STA 10+00 E ANODE HDR ANODE HEADER CABLE ER PROBE AT STA 14+20 ER 14+20 CSE AT STA 14+20 CSE 14+20 CSE 10+00 CSE AT STA 10+00

WIRE MARKER SCALE: NTS

CP-01

CP-02

PLANS FOR THE INSTALLATION OF: SWEETWATER DAM 36-INCH RAW WATER PIPELINE REPLACEMENT

SWEETWATER AUTHORITY

CORROSION MONITORING DETAILS - 2

DETAI	LO - Z		
1/4 SECTION	W.O. # N/A		
TANTS, INC.	5/18/2011	B.P. # N/A	
=	DATE	SHEET	
R AUTHORITY	5/18/2011	18 OF 18	

No. CR 1137 431 WEST BASELINE ROAD CLAREMONT, CA 91711-1608

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REV. DATE DESCRIPTION BY APPVD. DESIGN BY: S. FOX SCALE: AS NOTED GEI CONSULT. DRAWN BY: A. OLMOS DATE: MAY 18, 2011 **ENGINEER PE** CHECKED BY: B. CLARK DESIGN# 20104024 В AS CONSTRUCTED: PAVEMENT#: N/A APPROVED DATE